251 S. TEXAS AVE.

HENDERSON, NEVADA 89015

PERMIT SET

ABBREVIATIONS

ABV.	ABOVE	MAS.	MASONRY
AFF	ABOVE FINISHED FLOOR	MAX	MAXIMUM
AOT	ADOVE I INISTIED I EOOK	MAX. MAT.	
ACT ADD'L	ACOUSTICAL TILE	IVIA I	MATERIAL
	ADDITIONAL	MECH	MECHANICAL
AHU	AIR HANDLING UNIT	MAS.	METAL
		MFR	MANUFACTURER
AB	ANCHORROLT	MIN.	MINIMUM
AD	ANCHOR BOLT		
APPROX.	APPROXIMATE	MIR.	MIRROR
ARCH.	ARCHITECT, ARCHITECTURAL	MISC.	MISCELLANEOUS
	•	MO	MASONRY OPENING
вм	BEAM	MTD.	MOUNTED
		WITD.	WOONTED
BRG.	BEARING		NARIANIRIORENIOER
BLKG.	BLOCKING	ND	NAPKIN DISPENSER
BD	BOARD	NIC	NOT IN CONTRACT
BLDG	BUILDING	NV	NAPKIN VENDOR
BL	BUILDING LINE	NTS	NOT TO SCALE
DL	BUILDING LINE	NIO	NOT TO SCALL
CAB.	CABINET	OC	ON CENTER
CANT.	CANTILEVER	OD	OUTSIDE DIAMETER
CPT	CARPET	OFCI	OWNER FURNISHED,
01.0		0, 0,	CONTR. INSTALLED
CLG.	CEILING	0501	
CL	CENTERLINE	OFOI	OWNER FURNISHED,
CLASS.	CLASSIFICATION		OWNER INSTALLED
CT	CERAMIC TILE	OH	OVERHEAD
		OHG	OVERHANG
COL.	COLUMN COMMODITY	OPNG	OPENING
	CONCRETE	OPP	OPPOSITE
CMU	CONCRETE MASONRY UNIT		
COND.	CONDENSER	PC PL	PIECE
CI.	CONTROL JOINT	PI	PLATE
CJ CONT. CONTR.	CONTROL SOINT	DIAM	PLASTIC LAMINATE
CONT.	CONTINUOUS		
CONTR.	CONTRACTOR	PLMG.	PLUMBING
CURT.	CURTAIN	PLYWD.	PLYWOOD
		PNLG.	PANELING
DESIG.	DECICNATED	PNT.	
	DESIGNATED		
DET.	DETAIL		POLYETHYLENE
DIA.	DIAMETER	PT	PRESSURE TREATED
DIM.	DIMENSION	PVC	POLYVINYL CHLORIDE
DISP.	DISPENSER		
		QT	QUARRY TILE
DF	DRINKING FOUNTAIN		
DN	DOWN	QTR.	QUARTER RADIUS
DS	DOWNSPOUT		
DWG.	DRAWING	R	RISER
		RD	ROOF DRAIN
EIFS	EXTERIOR INSULATING	RE:	REFER
EIFS			
	FACING SYSTEM	PNT.	REINFORCEMENT
EJ	EXPANSION JOINT	REQ'D	REQUIRED
ELEC.	ELECTRICAL	RM	ROOM
ELEV.	ELEVATION	RO	ROUGH OPENING
ENAM.	ENAMEL		110001101211110
EINAIVI.		00	00110 0005
ENVIR.	ENVIRONMENT	SC	SOLID CORE
EQUIP.	EQUIPMENT	SCHED.	SCHEDULE
EW	EACH WAY	SD	SOAP DISPENSER
FXIST	EXISTING	SECT	SECTION
EXP.	EXPANSION	SF	
EXT.		SHT	SHEET
	EXTERIOR	SHTG	OLICATION
EXH.		SHIG	SHEATHING
	EXHAUST FAN		
	EXHAUST FAN	SIM	SIMILAR
FAR	FLOOR AREA RATIO	SIM SP	SIMILAR SPACE
	FLOOR AREA RATIO	SIM SP	SPACE
FD	FLOOR AREA RATIO FLOOR DRAIN	SIM SP SPEC.	SPACE SPECIFICATIONS
FD FDN	FLOOR AREA RATIO FLOOR DRAIN FOUNDATION	SIM SP SPEC. S/S	SPACE SPECIFICATIONS STAINLESS STEEL
FD FDN FE	FLOOR AREA RATIO FLOOR DRAIN FOUNDATION FIRE EXTINGUISHER	SIM SP SPEC. S/S S	SPACE SPECIFICATIONS STAINLESS STEEL SINK
FD FDN FE FEC	FLOOR AREA RATIO FLOOR DRAIN FOUNDATION FIRE EXTINGUISHER FIRE EXTINGUISHER CABINET	SIM SP SPEC. S/S S	SPACE SPECIFICATIONS STAINLESS STEEL SINK SOUND TRANSMISSION
FD FDN FE FEC FIN.	FLOOR AREA RATIO FLOOR DRAIN FOUNDATION FIRE EXTINGUISHER	SIM SP SPEC. S/S S STC	SPACE SPECIFICATIONS STAINLESS STEEL SINK SOUND TRANSMISSION COEFFICIENT
FD FDN FE FEC FIN.	FLOOR AREA RATIO FLOOR DRAIN FOUNDATION FIRE EXTINGUISHER FIRE EXTINGUISHER CABINET	SIM SP SPEC. S/S S STC	SPACE SPECIFICATIONS STAINLESS STEEL SINK SOUND TRANSMISSION
FD FDN FE FEC FIN. FIXT.	FLOOR AREA RATIO FLOOR DRAIN FOUNDATION FIRE EXTINGUISHER FIRE EXTINGUISHER CABINET FINISH FIXTURE	SIM SP SPEC. S/S S STC	SPACE SPECIFICATIONS STAINLESS STEEL SINK SOUND TRANSMISSION COEFFICIENT STORAGE
FD FDN FE FEC FIN. FIXT. FLEX.	FLOOR AREA RATIO FLOOR DRAIN FOUNDATION FIRE EXTINGUISHER FIRE EXTINGUISHER CABINET FINISH FIXTURE FLEXIBLE	SIM SP SPEC. S/S S STC STOR. STD.	SPACE SPECIFICATIONS STAINLESS STEEL SINK SOUND TRANSMISSION COEFFICIENT STORAGE STANDARD
FD FDN FE FEC FIN. FIXT. FLEX.	FLOOR AREA RATIO FLOOR DRAIN FOUNDATION FIRE EXTINGUISHER FIRE EXTINGUISHER CABINET FINISH FIXTURE FLEXIBLE	SIM SP SPEC. S/S S STC STOR. STD. STL.	SPACE SPECIFICATIONS STAINLESS STEEL SINK SOUND TRANSMISSION COEFFICIENT STORAGE STANDARD STEEL
FD FDN FE FEC FIN. FIXT. FLEX. FLR FLUOR.	FLOOR AREA RATIO FLOOR DRAIN FOUNDATION FIRE EXTINGUISHER FIRE EXTINGUISHER CABINET FINISH FIXTURE FLEXIBLE	SIM SP SPEC. S/S S STC STOR. STD. STL. STRUCT.	SPACE SPECIFICATIONS STAINLESS STEEL SINK SOUND TRANSMISSION COEFFICIENT STORAGE STANDARD STEEL STRUCTURAL
FD FDN FE FEC FIN. FIXT. FLEX. FLR FLUOR. FR	FLOOR AREA RATIO FLOOR DRAIN FOUNDATION FIRE EXTINGUISHER FIRE EXTINGUISHER CABINET FINISH FIXTURE FLEXIBLE FLOOR FLUORESCENT FIRE RETARDANT	SIM SP SPEC. S/S S STC STOR. STD. STL.	SPACE SPECIFICATIONS STAINLESS STEEL SINK SOUND TRANSMISSION COEFFICIENT STORAGE STANDARD STEEL STRUCTURAL
FD FDN FE FEC FIN. FIXT. FLEX. FLR FLUOR. FR FTG.	FLOOR AREA RATIO FLOOR DRAIN FOUNDATION FIRE EXTINGUISHER FIRE EXTINGUISHER CABINET FINISH FIXTURE FLEXIBLE FLOOR FLUORESCENT FIRE RETARDANT FOOTING	SIM SP SPEC. S/S S STC STOR. STD. STL. STRUCT. SUSP.	SPACE SPECIFICATIONS STAINLESS STEEL SINK SOUND TRANSMISSION COEFFICIENT STORAGE STANDARD STEEL STRUCTURAL SUSPENDED
FD FDN FE FEC FIN. FIXT. FLEX. FLR FLUOR. FR	FLOOR AREA RATIO FLOOR DRAIN FOUNDATION FIRE EXTINGUISHER FIRE EXTINGUISHER CABINET FINISH FIXTURE FLEXIBLE FLOOR FLUORESCENT FIRE RETARDANT	SIM SP SPEC. S/S S STC STOR. STD. STL. STRUCT.	SPACE SPECIFICATIONS STAINLESS STEEL SINK SOUND TRANSMISSION COEFFICIENT STORAGE STANDARD STEEL STRUCTURAL
FD FDN FE FEC FIN. FIXT. FLEX. FLR FLUOR. FR FTG.	FLOOR AREA RATIO FLOOR DRAIN FOUNDATION FIRE EXTINGUISHER FIRE EXTINGUISHER CABINET FINISH FIXTURE FLEXIBLE FLOOR FLUORESCENT FIRE RETARDANT FOOTING	SIM SP SPEC. S/S S STC STOR. STD. STL. STRUCT. SUSP.	SPACE SPECIFICATIONS STAINLESS STEEL SINK SOUND TRANSMISSION COEFFICIENT STORAGE STANDARD STEEL STRUCTURAL SUSPENDED
FD FDN FE FEC FIN. FIXT. FLEX. FLR FLUOR. FR FTG. FURR.	FLOOR AREA RATIO FLOOR DRAIN FOUNDATION FIRE EXTINGUISHER FIRE EXTINGUISHER CABINET FINISH FIXTURE FLEXIBLE FLOOR FLUORESCENT FIRE RETARDANT FOOTING FURRING	SIM SP SPEC. S/S S STC STOR. STD. STL. STRUCT. SUSP. T.BD. TB	SPACE SPECIFICATIONS STAINLESS STEEL SINK SOUND TRANSMISSION COEFFICIENT STORAGE STANDARD STEEL STRUCTURAL SUSPENDED TACK BOARD TOWEL BAR
FD FDN FE FEC FIN. FIXT. FLEX. FLR FLUOR. FR FTG. FURR.	FLOOR AREA RATIO FLOOR DRAIN FOUNDATION FIRE EXTINGUISHER FIRE EXTINGUISHER CABINET FINISH FIXTURE FLEXIBLE FLOOR FLUORESCENT FIRE RETARDANT FOOTING FURRING GAUGE	SIM SP SPEC. S/S S STC STOR. STD. STL. STRUCT. SUSP. T.BD. TB TD	SPACE SPECIFICATIONS STAINLESS STEEL SINK SOUND TRANSMISSION COEFFICIENT STORAGE STANDARD STEEL STRUCTURAL SUSPENDED TACK BOARD TOWEL BAR TOWEL DISPENSER
FD FDN FE FEC FIN. FIXT. FLEX. FLR FLUOR. FR FTG. FURR. GA GALV.	FLOOR AREA RATIO FLOOR DRAIN FOUNDATION FIRE EXTINGUISHER FIRE EXTINGUISHER CABINET FINISH FIXTURE FLEXIBLE FLOOR FLUORESCENT FIRE RETARDANT FOOTING FURRING GAUGE GALVANIZED	SIM SP SPEC. S/S S STC STOR. STD. STL. STRUCT. SUSP. T.BD. TB TD TELE.	SPACE SPECIFICATIONS STAINLESS STEEL SINK SOUND TRANSMISSION COEFFICIENT STORAGE STANDARD STEEL STRUCTURAL SUSPENDED TACK BOARD TOWEL BAR TOWEL DISPENSER TELEPHONE
FD FDN FE FEC FIN. FIXT. FLEX. FLR FLUOR. FR FTG. FURR. GA GALV. GEN.	FLOOR AREA RATIO FLOOR DRAIN FOUNDATION FIRE EXTINGUISHER FIRE EXTINGUISHER CABINET FINISH FIXTURE FLEXIBLE FLOOR FLUORESCENT FIRE RETARDANT FOOTING FURRING GAUGE GALVANIZED GENERAL	SIM SP SPEC. S/S S STC STOR. STD. STL. STRUCT. SUSP. T.BD. TB TD TELE. THLD.	SPACE SPECIFICATIONS STAINLESS STEEL SINK SOUND TRANSMISSION COEFFICIENT STORAGE STANDARD STEEL STRUCTURAL SUSPENDED TACK BOARD TOWEL BAR TOWEL DISPENSER TELEPHONE THRESHOLD
FD FDN FE FEC FIN. FIXT. FLEX. FLR FLUOR. FR FTG. FURR. GA GALV. GEN. GL	FLOOR AREA RATIO FLOOR DRAIN FOUNDATION FIRE EXTINGUISHER FIRE EXTINGUISHER CABINET FINISH FIXTURE FLEXIBLE FLOOR FLUORESCENT FIRE RETARDANT FOOTING FURRING GAUGE GALVANIZED GENERAL GLASS GLAZED	SIM SP SPEC. S/S S STC STOR. STD. STL. STRUCT. SUSP. T.BD. TB TD TELE. THLD. TOIL.	SPACE SPECIFICATIONS STAINLESS STEEL SINK SOUND TRANSMISSION COEFFICIENT STORAGE STANDARD STEEL STRUCTURAL SUSPENDED TACK BOARD TOWEL BAR TOWEL DISPENSER TELEPHONE THRESHOLD TOILET
FD FDN FE FEC FIN. FIXT. FLEX. FLR FLUOR. FR FTG. FURR. GA GALV. GEN.	FLOOR AREA RATIO FLOOR DRAIN FOUNDATION FIRE EXTINGUISHER FIRE EXTINGUISHER CABINET FINISH FIXTURE FLEXIBLE FLOOR FLUORESCENT FIRE RETARDANT FOOTING FURRING GAUGE GALVANIZED GENERAL GLASS GLAZED	SIM SP SPEC. S/S S STC STOR. STD. STL. STRUCT. SUSP. T.BD. TB TD TELE. THLD.	SPACE SPECIFICATIONS STAINLESS STEEL SINK SOUND TRANSMISSION COEFFICIENT STORAGE STANDARD STEEL STRUCTURAL SUSPENDED TACK BOARD TOWEL BAR TOWEL DISPENSER TELEPHONE THRESHOLD
FD FDN FE FEC FIN. FIXT. FLEX. FLR FLUOR. FR FTG. FURR. GA GALV. GEN. GL	FLOOR AREA RATIO FLOOR DRAIN FOUNDATION FIRE EXTINGUISHER FIRE EXTINGUISHER CABINET FINISH FIXTURE FLEXIBLE FLOOR FLUORESCENT FIRE RETARDANT FOOTING FURRING GAUGE GALVANIZED GENERAL GLASS GLAZED	SIM SP SPEC. S/S S STC STOR. STD. STL. STRUCT. SUSP. T.BD. TB TD TELE. THLD. TOIL.	SPACE SPECIFICATIONS STAINLESS STEEL SINK SOUND TRANSMISSION COEFFICIENT STORAGE STANDARD STEEL STRUCTURAL SUSPENDED TACK BOARD TOWEL BAR TOWEL DISPENSER TELEPHONE THRESHOLD TOILET
FD FDN FE FEC FIN. FIXT. FLEX. FLR FLUOR. FR FTG. FURR. GA GALV. GEN. GL GYP. BD.	FLOOR AREA RATIO FLOOR DRAIN FOUNDATION FIRE EXTINGUISHER FIRE EXTINGUISHER CABINET FINISH FIXTURE FLEXIBLE FLOOR FLUORESCENT FIRE RETARDANT FOOTING FURRING GAUGE GALVANIZED GENERAL GLASS GLAZED GYPSUM BOARD	SIM SP SPEC. S/S S STC STOR. STD. STL. STRUCT. SUSP. T.BD. TB TD TELE. THLD. TOIL. TPH TR	SPACE SPECIFICATIONS STAINLESS STEEL SINK SOUND TRANSMISSION COEFFICIENT STORAGE STANDARD STEEL STRUCTURAL SUSPENDED TACK BOARD TOWEL BAR TOWEL DISPENSER TELEPHONE THRESHOLD TOILET TOILET PAPER HOLDER TOWEL RECEPTACLE
FD FDN FE FEC FIN. FIXT. FLEX. FLR FLUOR. FR FTG. FURR. GA GALV. GEN. GL GYP. BD. HB	FLOOR AREA RATIO FLOOR DRAIN FOUNDATION FIRE EXTINGUISHER FIRE EXTINGUISHER CABINET FINISH FIXTURE FLEXIBLE FLOOR FLUORESCENT FIRE RETARDANT FOOTING FURRING GAUGE GALVANIZED GENERAL GLASS GLAZED GYPSUM BOARD HOSE BIB	SIM SP SPEC. S/S S STC STOR. STD. STL. STRUCT. SUSP. T.BD. TB TD TELE. THLD. TOIL. TPH	SPACE SPECIFICATIONS STAINLESS STEEL SINK SOUND TRANSMISSION COEFFICIENT STORAGE STANDARD STEEL STRUCTURAL SUSPENDED TACK BOARD TOWEL BAR TOWEL DISPENSER TELEPHONE THRESHOLD TOILET TOILET PAPER HOLDER
FD FDN FE FEC FIN. FIXT. FLEX. FLR FLUOR. FR FTG. FURR. GA GALV. GEN. GL GYP. BD. HB HC	FLOOR AREA RATIO FLOOR DRAIN FOUNDATION FIRE EXTINGUISHER FIRE EXTINGUISHER CABINET FINISH FIXTURE FLEXIBLE FLOOR FLUORESCENT FIRE RETARDANT FOOTING FURRING GAUGE GALVANIZED GENERAL GLASS GLAZED GYPSUM BOARD HOSE BIB HOLLOW CORE	SIM SP SPEC. S/S S STC STOR. STD. STL. STRUCT. SUSP. T.BD. TB TD TELE. THLD. TOIL. TPH TR TYP.	SPACE SPECIFICATIONS STAINLESS STEEL SINK SOUND TRANSMISSION COEFFICIENT STORAGE STANDARD STEEL STRUCTURAL SUSPENDED TACK BOARD TOWEL BAR TOWEL DISPENSER TELEPHONE THRESHOLD TOILET TOILET PAPER HOLDER TOWEL RECEPTACLE TYPICAL
FD FDN FE FEC FIN. FIXT. FLEX. FLR FLUOR. FR FTG. FURR. GA GALV. GEN. GL GYP. BD. HB HC HD	FLOOR AREA RATIO FLOOR DRAIN FOUNDATION FIRE EXTINGUISHER FIRE EXTINGUISHER CABINET FINISH FIXTURE FLEXIBLE FLOOR FLUORESCENT FIRE RETARDANT FOOTING FURRING GAUGE GALVANIZED GENERAL GLASS GLAZED GYPSUM BOARD HOSE BIB HOLLOW CORE HEAD	SIM SP SPEC. S/S S STC STOR. STD. STL. STRUCT. SUSP. T.BD. TB TD TELE. THLD. TOIL. TPH TR	SPACE SPECIFICATIONS STAINLESS STEEL SINK SOUND TRANSMISSION COEFFICIENT STORAGE STANDARD STEEL STRUCTURAL SUSPENDED TACK BOARD TOWEL BAR TOWEL DISPENSER TELEPHONE THRESHOLD TOILET TOILET PAPER HOLDER TOWEL RECEPTACLE TYPICAL UNLESS NOTED
FD FDN FE FEC FIN. FIXT. FLEX. FLR FLUOR. FR FTG. FURR. GA GALV. GEN. GL GYP. BD. HB HC	FLOOR AREA RATIO FLOOR DRAIN FOUNDATION FIRE EXTINGUISHER FIRE EXTINGUISHER CABINET FINISH FIXTURE FLEXIBLE FLOOR FLUORESCENT FIRE RETARDANT FOOTING FURRING GAUGE GALVANIZED GENERAL GLASS GLAZED GYPSUM BOARD HOSE BIB HOLLOW CORE	SIM SP SPEC. S/S S STC STOR. STD. STL. STRUCT. SUSP. T.BD. TB TD TELE. THLD. TOIL. TPH TR TYP.	SPACE SPECIFICATIONS STAINLESS STEEL SINK SOUND TRANSMISSION COEFFICIENT STORAGE STANDARD STEEL STRUCTURAL SUSPENDED TACK BOARD TOWEL BAR TOWEL DISPENSER TELEPHONE THRESHOLD TOILET TOILET PAPER HOLDER TOWEL RECEPTACLE TYPICAL
FD FDN FE FEC FIN. FIXT. FLEX. FLR FLUOR. FR FTG. FURR. GA GALV. GEN. GL GYP. BD. HB HC HD	FLOOR AREA RATIO FLOOR DRAIN FOUNDATION FIRE EXTINGUISHER FIRE EXTINGUISHER CABINET FINISH FIXTURE FLEXIBLE FLOOR FLUORESCENT FIRE RETARDANT FOOTING FURRING GAUGE GALVANIZED GENERAL GLASS GLAZED GYPSUM BOARD HOSE BIB HOLLOW CORE HEAD	SIM SP SPEC. S/S S STC STOR. STD. STL. STRUCT. SUSP. T.BD. TB TD TELE. THLD. TOIL. TPH TR TYP.	SPACE SPECIFICATIONS STAINLESS STEEL SINK SOUND TRANSMISSION COEFFICIENT STORAGE STANDARD STEEL STRUCTURAL SUSPENDED TACK BOARD TOWEL BAR TOWEL DISPENSER TELEPHONE THRESHOLD TOILET TOILET PAPER HOLDER TOWEL RECEPTACLE TYPICAL UNLESS NOTED
FD FDN FE FEC FIN. FIXT. FLEX. FLR FLUOR. FR FTG. FURR. GA GALV. GEN. GL GYP. BD. HB HC HD HDW HORIZ.	FLOOR AREA RATIO FLOOR DRAIN FOUNDATION FIRE EXTINGUISHER FIRE EXTINGUISHER CABINET FINISH FIXTURE FLEXIBLE FLOOR FLUORESCENT FIRE RETARDANT FOOTING FURRING GAUGE GALVANIZED GENERAL GLASS GLAZED GYPSUM BOARD HOSE BIB HOLLOW CORE HEAD HARDWARE HORIZONTAL	SIM SP SPEC. S/S S STC STOR. STD. STL. STRUCT. SUSP. T.BD. TB TD TELE. THLD. TOIL. TPH TR TYP. UNO	SPACE SPECIFICATIONS STAINLESS STEEL SINK SOUND TRANSMISSION COEFFICIENT STORAGE STANDARD STEEL STRUCTURAL SUSPENDED TACK BOARD TOWEL BAR TOWEL DISPENSER TELEPHONE THRESHOLD TOILET TOILET PAPER HOLDER TOWEL RECEPTACLE TYPICAL UNLESS NOTED OTHERWISE
FD FDN FE FEC FIN. FIXT. FLEX. FLR FLUOR. FR FTG. FURR. GA GALV. GEN. GL GYP. BD. HB HC HD HDW HORIZ. HM	FLOOR AREA RATIO FLOOR DRAIN FOUNDATION FIRE EXTINGUISHER FIRE EXTINGUISHER CABINET FINISH FIXTURE FLEXIBLE FLOOR FLUORESCENT FIRE RETARDANT FOOTING FURRING GAUGE GALVANIZED GENERAL GLASS GLAZED GYPSUM BOARD HOSE BIB HOLLOW CORE HEAD HARDWARE HORIZONTAL HOLLOW METAL	SIM SP SPEC. S/S S STC STOR. STD. STL. STRUCT. SUSP. T.BD. TB TD TELE. THLD. TOIL. TPH TR TYP. UNO UV	SPACE SPECIFICATIONS STAINLESS STEEL SINK SOUND TRANSMISSION COEFFICIENT STORAGE STANDARD STEEL STRUCTURAL SUSPENDED TACK BOARD TOWEL BAR TOWEL DISPENSER TELEPHONE THRESHOLD TOILET TOILET PAPER HOLDER TOWEL RECEPTACLE TYPICAL UNLESS NOTED OTHERWISE UNIT VENTILATOR
FD FDN FE FEC FIN. FIXT. FLEX. FLR FLUOR. FR FTG. FURR. GA GALV. GEN. GL GYP. BD. HB HC HD HDW HORIZ. HM HT	FLOOR AREA RATIO FLOOR DRAIN FOUNDATION FIRE EXTINGUISHER FIRE EXTINGUISHER CABINET FINISH FIXTURE FLEXIBLE FLOOR FLUORESCENT FIRE RETARDANT FOOTING FURRING GAUGE GALVANIZED GENERAL GLASS GLAZED GYPSUM BOARD HOSE BIB HOLLOW CORE HEAD HARDWARE HORIZONTAL HOLLOW METAL HEIGHT	SIM SP SPEC. S/S S STC STOR. STD. STL. STRUCT. SUSP. T.BD. TB TD TELE. THLD. TOIL. TPH TR TYP. UNO UV VB	SPACE SPECIFICATIONS STAINLESS STEEL SINK SOUND TRANSMISSION COEFFICIENT STORAGE STANDARD STEEL STRUCTURAL SUSPENDED TACK BOARD TOWEL BAR TOWEL DISPENSER TELEPHONE THRESHOLD TOILET TOILET PAPER HOLDER TOWEL RECEPTACLE TYPICAL UNLESS NOTED OTHERWISE UNIT VENTILATOR
FD FDN FE FEC FIN. FIXT. FLEX. FLR FLUOR. FR FTG. FURR. GA GALV. GEN. GL GYP. BD. HB HC HD HDW HORIZ. HM HT ID	FLOOR AREA RATIO FLOOR DRAIN FOUNDATION FIRE EXTINGUISHER FIRE EXTINGUISHER CABINET FINISH FIXTURE FLEXIBLE FLOOR FLUORESCENT FIRE RETARDANT FOOTING FURRING GAUGE GALVANIZED GENERAL GLASS GLAZED GYPSUM BOARD HOSE BIB HOLLOW CORE HEAD HARDWARE HORIZONTAL HOLLOW METAL HEIGHT INSIDE DIAMETER	SIM SP SPEC. S/S S STC STOR. STD. STL. STRUCT. SUSP. T.BD. TB TD TELE. THLD. TOIL. TPH TR TYP. UNO UV VB VCT	SPACE SPECIFICATIONS STAINLESS STEEL SINK SOUND TRANSMISSION COEFFICIENT STORAGE STANDARD STEEL STRUCTURAL SUSPENDED TACK BOARD TOWEL BAR TOWEL DISPENSER TELEPHONE THRESHOLD TOILET TOILET PAPER HOLDER TOWEL RECEPTACLE TYPICAL UNLESS NOTED OTHERWISE UNIT VENTILATOR VINYL BASE VINYL COMPOSITE TILE
FD FDN FE FEC FIN. FIXT. FLEX. FLR FLUOR. FR FTG. FURR. GA GALV. GEN. GL GYP. BD. HB HC HD HDW HORIZ. HM HT	FLOOR AREA RATIO FLOOR DRAIN FOUNDATION FIRE EXTINGUISHER FIRE EXTINGUISHER CABINET FINISH FIXTURE FLEXIBLE FLOOR FLUORESCENT FIRE RETARDANT FOOTING FURRING GAUGE GALVANIZED GENERAL GLASS GLAZED GYPSUM BOARD HOSE BIB HOLLOW CORE HEAD HARDWARE HORIZONTAL HOLLOW METAL HEIGHT	SIM SP SPEC. S/S S STC STOR. STD. STL. STRUCT. SUSP. T.BD. TB TD TELE. THLD. TOIL. TPH TR TYP. UNO UV VB	SPACE SPECIFICATIONS STAINLESS STEEL SINK SOUND TRANSMISSION COEFFICIENT STORAGE STANDARD STEEL STRUCTURAL SUSPENDED TACK BOARD TOWEL BAR TOWEL DISPENSER TELEPHONE THRESHOLD TOILET TOILET PAPER HOLDER TOWEL RECEPTACLE TYPICAL UNLESS NOTED OTHERWISE UNIT VENTILATOR
FD FDN FE FEC FIN. FIXT. FLEX. FLR FLUOR. FR FTG. FURR. GA GALV. GEN. GL GYP. BD. HB HC HD HDW HORIZ. HM HT ID INSUL.	FLOOR AREA RATIO FLOOR DRAIN FOUNDATION FIRE EXTINGUISHER FIRE EXTINGUISHER CABINET FINISH FIXTURE FLEXIBLE FLOOR FLUORESCENT FIRE RETARDANT FOOTING FURRING GAUGE GALVANIZED GENERAL GLASS GLAZED GYPSUM BOARD HOSE BIB HOLLOW CORE HEAD HARDWARE HORIZONTAL HOLLOW METAL HEIGHT INSIDE DIAMETER INSULATE, INSULATION	SIM SP SPEC. S/S S STC STOR. STD. STL. STRUCT. SUSP. T.BD. TB TD TELE. THLD. TOIL. TPH TR TYP. UNO UV VB VCT VERT.	SPACE SPECIFICATIONS STAINLESS STEEL SINK SOUND TRANSMISSION COEFFICIENT STORAGE STANDARD STEEL STRUCTURAL SUSPENDED TACK BOARD TOWEL BAR TOWEL DISPENSER TELEPHONE THRESHOLD TOILET TOILET PAPER HOLDER TOWEL RECEPTACLE TYPICAL UNLESS NOTED OTHERWISE UNIT VENTILATOR VINYL BASE VINYL COMPOSITE TILE VERTICAL
FD FDN FE FEC FIN. FIXT. FLEX. FLR FLUOR. FR FTG. FURR. GA GALV. GEN. GL GYP. BD. HB HC HD HDW HORIZ. HM HT ID	FLOOR AREA RATIO FLOOR DRAIN FOUNDATION FIRE EXTINGUISHER FIRE EXTINGUISHER CABINET FINISH FIXTURE FLEXIBLE FLOOR FLUORESCENT FIRE RETARDANT FOOTING FURRING GAUGE GALVANIZED GENERAL GLASS GLAZED GYPSUM BOARD HOSE BIB HOLLOW CORE HEAD HARDWARE HORIZONTAL HOLLOW METAL HEIGHT INSIDE DIAMETER	SIM SP SPEC. S/S S STC STOR. STD. STL. STRUCT. SUSP. T.BD. TB TD TELE. THLD. TOIL. TPH TR TYP. UNO UV VB VCT VERT. VEST.	SPACE SPECIFICATIONS STAINLESS STEEL SINK SOUND TRANSMISSION COEFFICIENT STORAGE STANDARD STEEL STRUCTURAL SUSPENDED TACK BOARD TOWEL BAR TOWEL DISPENSER TELEPHONE THRESHOLD TOILET TOILET PAPER HOLDER TOWEL RECEPTACLE TYPICAL UNLESS NOTED OTHERWISE UNIT VENTILATOR VINYL BASE VINYL COMPOSITE TILE VERTICAL VESTIBULE
FD FDN FE FEC FIN. FIXT. FLEX. FLR FLUOR. FR FTG. FURR. GA GALV. GEN. GL GYP. BD. HB HC HD HORIZ. HM HT ID INSUL. INT.	FLOOR AREA RATIO FLOOR DRAIN FOUNDATION FIRE EXTINGUISHER FIRE EXTINGUISHER CABINET FINISH FIXTURE FLEXIBLE FLOOR FLUORESCENT FIRE RETARDANT FOOTING FURRING GAUGE GALVANIZED GENERAL GLASS GLAZED GYPSUM BOARD HOSE BIB HOLLOW CORE HEAD HARDWARE HORIZONTAL HOLLOW METAL HEIGHT INSIDE DIAMETER INSULATE, INSULATION INTERIOR	SIM SP SPEC. S/S S STC STOR. STD. STL. STRUCT. SUSP. T.BD. TB TD TELE. THLD. TOIL. TPH TR TYP. UNO UV VB VCT VERT.	SPACE SPECIFICATIONS STAINLESS STEEL SINK SOUND TRANSMISSION COEFFICIENT STORAGE STANDARD STEEL STRUCTURAL SUSPENDED TACK BOARD TOWEL BAR TOWEL DISPENSER TELEPHONE THRESHOLD TOILET TOILET PAPER HOLDER TOWEL RECEPTACLE TYPICAL UNLESS NOTED OTHERWISE UNIT VENTILATOR VINYL BASE VINYL COMPOSITE TILE VERTICAL
FD FDN FE FEC FIN. FIXT. FLEX. FLR FLUOR. FR FTG. FURR. GALV. GEN. GL GYP. BD. HB HC HD HORIZ. HM HT ID INSUL. INT. JAN.	FLOOR AREA RATIO FLOOR DRAIN FOUNDATION FIRE EXTINGUISHER FIRE EXTINGUISHER CABINET FINISH FIXTURE FLEXIBLE FLOOR FLUORESCENT FIRE RETARDANT FOOTING FURRING GAUGE GALVANIZED GENERAL GLASS GLAZED GYPSUM BOARD HOSE BIB HOLLOW CORE HEAD HARDWARE HORIZONTAL HOLLOW METAL HEIGHT INSIDE DIAMETER INSULATE, INSULATION INTERIOR	SIM SP SPEC. S/S S STC STOR. STD. STL. STRUCT. SUSP. T.BD. TB TD TELE. THLD. TOIL. TPH TR TYP. UNO UV VB VCT VERT. VEST. VWC	SPACE SPECIFICATIONS STAINLESS STEEL SINK SOUND TRANSMISSION COEFFICIENT STORAGE STANDARD STEEL STRUCTURAL SUSPENDED TACK BOARD TOWEL BAR TOWEL DISPENSER TELEPHONE THRESHOLD TOILET TOILET PAPER HOLDER TOWEL RECEPTACLE TYPICAL UNLESS NOTED OTHERWISE UNIT VENTILATOR VINYL BASE VINYL COMPOSITE TILE VERTICAL VESTIBULE VINYL WALL COVERING
FD FDN FE FEC FIN. FLEX. FLEX. FLEX. FLUOR. FR FTG. GALV. GEN. GL GYP. BD. HB HC HD HDW HORIZ. HM HT ID INSUL. INT. JAN. JST	FLOOR AREA RATIO FLOOR DRAIN FOUNDATION FIRE EXTINGUISHER FIRE EXTINGUISHER CABINET FINISH FIXTURE FLEXIBLE FLOOR FLUORESCENT FIRE RETARDANT FOOTING FURRING GAUGE GALVANIZED GENERAL GLASS GLAZED GYPSUM BOARD HOSE BIB HOLLOW CORE HEAD HARDWARE HORIZONTAL HOLLOW METAL HEIGHT INSIDE DIAMETER INSULATE, INSULATION INTERIOR JANITOR JOIST	SIM SP SPEC. S/S S STC STOR. STD. STL. STRUCT. SUSP. T.BD. TB TD TELE. THLD. TOIL. TPH TR TYP. UNO UV VB VCT VERT. VEST. VWC W/	SPACE SPECIFICATIONS STAINLESS STEEL SINK SOUND TRANSMISSION COEFFICIENT STORAGE STANDARD STEEL STRUCTURAL SUSPENDED TACK BOARD TOWEL BAR TOWEL DISPENSER TELEPHONE THRESHOLD TOILET TOILET PAPER HOLDER TOWEL RECEPTACLE TYPICAL UNLESS NOTED OTHERWISE UNIT VENTILATOR VINYL BASE VINYL COMPOSITE TILE VERTICAL VESTIBULE VINYL WALL COVERING
FD FDN FE FEC FIN. FIXT. FLEX. FLR FLUOR. FR FTG. FURR. GALV. GEN. GL GYP. BD. HB HC HD HORIZ. HM HT ID INSUL. INT. JAN.	FLOOR AREA RATIO FLOOR DRAIN FOUNDATION FIRE EXTINGUISHER FIRE EXTINGUISHER CABINET FINISH FIXTURE FLEXIBLE FLOOR FLUORESCENT FIRE RETARDANT FOOTING FURRING GAUGE GALVANIZED GENERAL GLASS GLAZED GYPSUM BOARD HOSE BIB HOLLOW CORE HEAD HARDWARE HORIZONTAL HOLLOW METAL HEIGHT INSIDE DIAMETER INSULATE, INSULATION INTERIOR	SIM SP SPEC. S/S S STC STOR. STD. STL. STRUCT. SUSP. T.BD. TB TD TELE. THLD. TOIL. TPH TR TYP. UNO UV VB VCT VERT. VEST. VWC	SPACE SPECIFICATIONS STAINLESS STEEL SINK SOUND TRANSMISSION COEFFICIENT STORAGE STANDARD STEEL STRUCTURAL SUSPENDED TACK BOARD TOWEL BAR TOWEL DISPENSER TELEPHONE THRESHOLD TOILET TOILET PAPER HOLDER TOWEL RECEPTACLE TYPICAL UNLESS NOTED OTHERWISE UNIT VENTILATOR VINYL BASE VINYL COMPOSITE TILE VERTICAL VESTIBULE VINYL WALL COVERING
FD FDN FE FEC FIN. FLEX. FLEX. FLEX. FLUOR. FR FTG. GALV. GEN. GL GYP. BD. HB HC HD HDW HORIZ. HM HT ID INSUL. INT. JAN. JST	FLOOR AREA RATIO FLOOR DRAIN FOUNDATION FIRE EXTINGUISHER FIRE EXTINGUISHER CABINET FINISH FIXTURE FLEXIBLE FLOOR FLUORESCENT FIRE RETARDANT FOOTING FURRING GAUGE GALVANIZED GENERAL GLASS GLAZED GYPSUM BOARD HOSE BIB HOLLOW CORE HEAD HARDWARE HORIZONTAL HOLLOW METAL HEIGHT INSIDE DIAMETER INSULATE, INSULATION INTERIOR JANITOR JOIST	SIM SP SPEC. S/S S STC STOR. STD. STL. STRUCT. SUSP. T.BD. TB TD TELE. THLD. TOIL. TPH TR TYP. UNO UV VB VCT VERT. VEST. VWC W/	SPACE SPECIFICATIONS STAINLESS STEEL SINK SOUND TRANSMISSION COEFFICIENT STORAGE STANDARD STEEL STRUCTURAL SUSPENDED TACK BOARD TOWEL BAR TOWEL DISPENSER TELEPHONE THRESHOLD TOILET TOILET PAPER HOLDER TOWEL RECEPTACLE TYPICAL UNLESS NOTED OTHERWISE UNIT VENTILATOR VINYL BASE VINYL COMPOSITE TILE VERTICAL VESTIBULE VINYL WALL COVERING
FD FDN FE FEC FIN.T. FLEX. FLUOR. FTG. FURR. GALV. GEN. GL HD HDW HORIZ. HM HT ID INST. INT. JAN. JST JT	FLOOR AREA RATIO FLOOR DRAIN FOUNDATION FIRE EXTINGUISHER FIRE EXTINGUISHER CABINET FINISH FIXTURE FLEXIBLE FLOOR FLUORESCENT FIRE RETARDANT FOOTING FURRING GAUGE GALVANIZED GENERAL GLASS GLAZED GYPSUM BOARD HOSE BIB HOLLOW CORE HEAD HARDWARE HORIZONTAL HOLLOW METAL HEIGHT INSIDE DIAMETER INSULATE, INSULATION INTERIOR JANITOR JOIST JOINT	SIM SP SPEC. S/S S STC STOR. STD. STL. STRUCT. SUSP. T.BD. TB TD TELE. THLD. TOIL. TPH TR TYP. UNO UV VB VCT VEST. VWC W/ WC W/ WC WD.A.	SPACE SPECIFICATIONS STAINLESS STEEL SINK SOUND TRANSMISSION COEFFICIENT STORAGE STANDARD STEEL STRUCTURAL SUSPENDED TACK BOARD TOWEL BAR TOWEL DISPENSER TELEPHONE THRESHOLD TOILET TOILET PAPER HOLDER TOWEL RECEPTACLE TYPICAL UNLESS NOTED OTHERWISE UNIT VENTILATOR VINYL BASE VINYL COMPOSITE TILE VERTICAL VESTIBULE VINYL WALL COVERING WITH WATER CLOSET WOOD
FD FDN FE FEC FIN.T. FLEX. FLUOR. FTG. FURR. GALV. GEN. GL HD HDW HORIZ. HM HT ID INST. INT. JAN. JST JT LAM.	FLOOR AREA RATIO FLOOR DRAIN FOUNDATION FIRE EXTINGUISHER FIRE EXTINGUISHER CABINET FINISH FIXTURE FLEXIBLE FLOOR FLUORESCENT FIRE RETARDANT FOOTING FURRING GAUGE GALVANIZED GENERAL GLASS GLAZED GYPSUM BOARD HOSE BIB HOLLOW CORE HEAD HARDWARE HORIZONTAL HOLLOW METAL HEIGHT INSIDE DIAMETER INSULATE, INSULATION INTERIOR JANITOR JOIST JOINT LAMINATE	SIM SP SPEC. S/S S STC STOR. STD. STL. STRUCT. SUSP. T.BD. TB TD TELE. THLD. TOIL. TPH TR TYP. UNO UV VB VCT VEST. VWC W/ WC WD.A. WDW.	SPACE SPECIFICATIONS STAINLESS STEEL SINK SOUND TRANSMISSION COEFFICIENT STORAGE STANDARD STEEL STRUCTURAL SUSPENDED TACK BOARD TOWEL BAR TOWEL DISPENSER TELEPHONE THRESHOLD TOILET TOILET PAPER HOLDER TOWEL RECEPTACLE TYPICAL UNLESS NOTED OTHERWISE UNIT VENTILATOR VINYL BASE VINYL COMPOSITE TILE VERTICAL VESTIBULE VINYL WALL COVERING WITH WATER CLOSET WOOD WINDOW
FD FDN FE FEC FIN.T. FLEX. FLEX. FLUOR. FT G. FURR. GALV. GEN. GL HDW HORIZ. HM HT ID INST. JAN. JST JT LAW. JAN. LAV.	FLOOR AREA RATIO FLOOR DRAIN FOUNDATION FIRE EXTINGUISHER FIRE EXTINGUISHER CABINET FINISH FIXTURE FLEXIBLE FLOOR FLUORESCENT FIRE RETARDANT FOOTING FURRING GAUGE GALVANIZED GENERAL GLASS GLAZED GYPSUM BOARD HOSE BIB HOLLOW CORE HEAD HARDWARE HORIZONTAL HOLLOW METAL HEIGHT INSIDE DIAMETER INSULATE, INSULATION INTERIOR JANITOR JOIST JOINT LAMINATE LAVATORY	SIM SP SPEC. S/S S STC STOR. STD. STL. STRUCT. SUSP. T.BD. TB TD TELE. THLD. TOIL. TPH TR TYP. UNO UV VB VCT VEST. VWC W/ WC WD.A. WDW. WH	SPACE SPECIFICATIONS STAINLESS STEEL SINK SOUND TRANSMISSION COEFFICIENT STORAGE STANDARD STEEL STRUCTURAL SUSPENDED TACK BOARD TOWEL BAR TOWEL DISPENSER TELEPHONE THRESHOLD TOILET TOILET PAPER HOLDER TOWEL RECEPTACLE TYPICAL UNLESS NOTED OTHERWISE UNIT VENTILATOR VINYL BASE VINYL COMPOSITE TILE VERTICAL VESTIBULE VINYL WALL COVERING WITH WATER CLOSET WOOD WINDOW WATER HEATER
FD FDN FE FEC FIN.T. FLEX. FLUOR. FR FTG. GALV. GEN. GGEN. HB HCD HDW HORIZ. HM HT ID INST. JAN. JST JT LAV. LG	FLOOR AREA RATIO FLOOR DRAIN FOUNDATION FIRE EXTINGUISHER FIRE EXTINGUISHER CABINET FINISH FIXTURE FLEXIBLE FLOOR FLUORESCENT FIRE RETARDANT FOOTING FURRING GAUGE GALVANIZED GENERAL GLASS GLAZED GYPSUM BOARD HOSE BIB HOLLOW CORE HEAD HARDWARE HORIZONTAL HOLLOW METAL HEIGHT INSIDE DIAMETER INSULATE, INSULATION INTERIOR JANITOR JOIST JOINT LAMINATE LAVATORY LONG	SIM SP SPEC. S/S S STC STOR. STL. STRUCT. SUSP. T.BD. TB TD TELE. THLD. TOIL. TPH TR TYP. UNO UV VB VCT VERT. VEST. VWC WD.A. WDW. WH W/R	SPACE SPECIFICATIONS STAINLESS STEEL SINK SOUND TRANSMISSION COEFFICIENT STORAGE STANDARD STEEL STRUCTURAL SUSPENDED TACK BOARD TOWEL BAR TOWEL DISPENSER TELEPHONE THRESHOLD TOILET TOILET PAPER HOLDER TOWEL RECEPTACLE TYPICAL UNLESS NOTED OTHERWISE UNIT VENTILATOR VINYL BASE VINYL COMPOSITE TILE VERTICAL VESTIBULE VINYL WALL COVERING WITH WATER CLOSET WOOD WINDOW WATER HEATER WATER RESISTANT
FD FDN FE FEC FIN.T. FLEX. FLEX. FLUOR. FT G. FURR. GALV. GEN. GL HDW HORIZ. HM HT ID INST. JAN. JST JT LAW. JAN. LAV.	FLOOR AREA RATIO FLOOR DRAIN FOUNDATION FIRE EXTINGUISHER FIRE EXTINGUISHER CABINET FINISH FIXTURE FLEXIBLE FLOOR FLUORESCENT FIRE RETARDANT FOOTING FURRING GAUGE GALVANIZED GENERAL GLASS GLAZED GYPSUM BOARD HOSE BIB HOLLOW CORE HEAD HARDWARE HORIZONTAL HOLLOW METAL HEIGHT INSIDE DIAMETER INSULATE, INSULATION INTERIOR JANITOR JOIST JOINT LAMINATE LAVATORY	SIM SP SPEC. S/S S STC STOR. STD. STL. STRUCT. SUSP. T.BD. TB TD TELE. THLD. TOIL. TPH TR TYP. UNO UV VB VCT VEST. VWC W/ WC WD.A. WDW. WH	SPACE SPECIFICATIONS STAINLESS STEEL SINK SOUND TRANSMISSION COEFFICIENT STORAGE STANDARD STEEL STRUCTURAL SUSPENDED TACK BOARD TOWEL BAR TOWEL DISPENSER TELEPHONE THRESHOLD TOILET TOILET PAPER HOLDER TOWEL RECEPTACLE TYPICAL UNLESS NOTED OTHERWISE UNIT VENTILATOR VINYL BASE VINYL COMPOSITE TILE VERTICAL VESTIBULE VINYL WALL COVERING WITH WATER CLOSET WOOD WINDOW WATER HEATER

DEFERRED SUBMITTAL STATEMENT

PLANS FOR SIGNAGE, FIRE SPRINKLER, AND FIRE MONITORING, SHALL BE SUBMITTED SEPARATELY AS DEFERRED SUBMITTALS BY NEVADA LICENSED CONTRACTORS. THESE SUBMITTALS SHALL BE REVIEWED AND APPROVED PRIOR TO INSTALLATION.

BUILDING DESCRIPTION

PROJECT TYPE:	NEW CONSTRUCTION
OCCUPANCY TYPE:	R-2
TYPE OF CONSTRUCTION:	V-B (combustible)
ALLOWABLE AREA (TABLE 503)	SEE LS101
FRONTAGE INCREASE	NO
FIRE SPRINKLER INCREASE	YES - S13R
TOTAL ALLOWABLE AREA	7000 SF (IBC TABLE 506.2)
ACTUAL AREA	3918 SF
ALLOWABLE HEIGHT	60 FT
ACTUAL HEIGHT	30'-10 ¹ / ₄ "
OCCUPANT LOAD	8 BEDROOMS

FIRE PROTECTION SYSTEMS

	OILIVIO	<u>'</u> _
		_
	YES	NO
AUTOMATIC FIRE SPRINKLER SYSTEM	X - S13	
ALTERNATIVE AUTOMATIC FIRE EXTINGUISHING SYSTEM		X
PORTABLE FIRE EXTINGUISHERS	Х	
FIRE EMERGENCY ALARM & DETECTION SYSTEMS	BY OTHERS	
HVAC & AIR DISTRIBUTION SYSTEM CONTROLS		Х
SMOKE CONTROL SYSTEMS		Х

FIRE-RESISTANT RATED CONSTRUCTION

					-							
							TAE	3LE	60°	1, 6	602.4 IBC	2012
BUILDING E	ELEME	NTS	RE	QUI	IRI	ED	PRO\	/IDE	D		UL RATI	NG
STRUCT	URAL	FRAME	NC)			NO					
EXTER		EARING WALLS	NC)			NO					
INTER		EARING WALLS	NC)			NO					
NON-BE		TERIOR WALLS	NC)			NO					
NON-BEA		ERIOR WALLS	NC)			NO					
FLOOR CO	NSTRU	JCTION	NC)			NO					
SEPARATION BETWEEN DWELLING UNITS		YES YES										
ROOF CO	NSTRU	JCTION	NC)			NO					
F	IRE BA	ARRIER	YE	S			YES				SEE SHI A601	EET
FIRE SEPA	RATIO	N DISTA	NC	E (F	T)	- Mea	sured to	CL	of	Str	eets	
NORTH	30'	SOUTH	l	30'		EAST	-	25.	5'	W	'EST	30'
ROOF COV	ERING	CLASS	IFIC	ATI	01	۷:						•
REQUIRED					Ρ	ROVIE	ED					

PROJECT TEAM OWNER MOTUS, LLC 1525 E. ONTARIO AVENUE, STE 101 CORONA, CA 92881 ARCHITECT OPA DESIGN STUDIO 7010 EASY WIND DRIVE, SUITE 200 AUSTIN, TX 78752 STRUCTURAL MONTGOMERY CONSULTING ENGINEERS, LLC 9680 W. TROPICANA AVE, SUITE 132 LAS VEGAS, NEVADA 89147 MEP MARIANO ENGINEERING 6040 SOUTH DURANGO DRIVE, STE 100 LAS VEGAS, NEVADA 89113 CIVIL DWYER ENGINEERING INC. 7310 SMOKE RANCH ROAD, STE E LAS VEGAS, NEVADA 89128 LANDSCAPE S2 DESIGN STUDIO 2126 DESCAPA CT	REQUIRED		PROVIDED		
1525 E. ONTARIO AVENUE, STE 101 CORONA, CA 92881 ARCHITECT OPA DESIGN STUDIO 7010 EASY WIND DRIVE, SUITE 200 AUSTIN, TX 78752 STRUCTURAL MONTGOMERY CONSULTING ENGINEERS, LLC 9680 W. TROPICANA AVE, SUITE 132 LAS VEGAS, NEVADA 89147 MEP MARIANO ENGINEERING 6040 SOUTH DURANGO DRIVE, STE 100 LAS VEGAS, NEVADA 89113 CIVIL DWYER ENGINEERING INC. 7310 SMOKE RANCH ROAD, STE E LAS VEGAS, NEVADA 89128 LANDSCAPE S2 DESIGN STUDIO	PROJECT	TEAM			
7010 EASY WIND DRIVE, SUITE 200 AUSTIN, TX 78752 STRUCTURAL MONTGOMERY CONSULTING ENGINEERS, LLC 9680 W. TROPICANA AVE, SUITE 132 LAS VEGAS, NEVADA 89147 MEP MARIANO ENGINEERING 6040 SOUTH DURANGO DRIVE, STE 100 LAS VEGAS, NEVADA 89113 CIVIL DWYER ENGINEERING INC. 7310 SMOKE RANCH ROAD, STE E LAS VEGAS, NEVADA 89128 LANDSCAPE S2 DESIGN STUDIO	OWNER	1525 E. ONT	ARIO AVENUE, STE	E 101	
9680 W. TROPICANA AVE, SUITE 132 LAS VEGAS, NEVADA 89147 MEP MARIANO ENGINEERING 6040 SOUTH DURANGO DRIVE, STE 100 LAS VEGAS, NEVADA 89113 CIVIL DWYER ENGINEERING INC. 7310 SMOKE RANCH ROAD, STE E LAS VEGAS, NEVADA 89128 LANDSCAPE S2 DESIGN STUDIO	ARCHITECT	7010 EASY V	VIND DRIVE, SUITE	200	
6040 SOUTH DURANGO DRIVE, STE 100 LAS VEGAS, NEVADA 89113 CIVIL DWYER ENGINEERING INC. 7310 SMOKE RANCH ROAD, STE E LAS VEGAS, NEVADA 89128 LANDSCAPE S2 DESIGN STUDIO	STRUCTURAL	9680 W. TROPICANA AVE, SUITE 132			
7310 SMOKE RANCH ROAD, STE E LAS VEGAS, NEVADA 89128 LANDSCAPE S2 DESIGN STUDIO	MEP	6040 SOUTH	I DURANGO DRIVE,	STE 100	
	CIVIL	7310 SMOKE	E RANCH ROAD, ST	EE	
LAS VEGAS, NEVADA 89123	LANDSCAPE	2125 PESCA	RA CT.		

CODE SUMMARY

2012 INTERNATIONAL BUILDING CODE
2012 INTERNATIONAL FIRE CODE
2012 UNIFORM MECHANICAL CODE
2012 UNIFORM PLUMBING CODE
2011 NATIONAL ELECTRIC CODE
2012 INTERNATIONAL CONSERVATION CODE
2009 ICC A117.1 2009 ACCESSIBILITY REQUIREMENTS

PROJECT LEGAL DESCRIPTION

APN: 179-18-710-194


LOT TWENTY (20) IN BLOCK TEN (10), HENDERSON TOWNSITE, AS SHOWN BY MAPS THEREOF ON FILE IN BOOK 3 OF PLATS, PAGE 42, AND AMENDED IN BOOK 16 OF PLATS, PAGE 32, IN THE OFFICE OF THE COUNTY RECORDER OF CLARK COUNTY, NEVADA.

SAID AREA CONTAINS APPROXIMATELY 0.15 ACRES.

INDEX OF DRAWINGS


A-001	COVER
C-1	1/7 COVER SHEET
C-2	2/7 GENERAL NOTES SHEET
C-3	3/7 SECTIONS & DETAILS SHEET
C-4	4/7 GEOMETRIC CONTROL PLAN
C-5	5/7 UTILITY PLAN
C-6	6/7 GRADING PLAN
C-7	7/7 HORIZONTAL CONTROL PLAN
IR-1.0	IRRIGATION PLAN
L-1.0	LANDSCAPE PLAN
A 000	ACCESSIBILITY NOTES
A-002	
	ACCESSIBILITY NOTES
A-100	SITE PLAN
	FIRST FLOOR PLAN
A-102	SECOND FLOOR PLAN
A-103	ROOF PLAN
A-104	FIRST FLOOR REFLECTED CEILING PLAN
A-105	SECOND FLOOR REFLECTED CEILING PLAN
A-201	EXTERIOR ELEVATIONS
A-202	EXTERIOR ELEVATIONS
A-301	BUILDING SECTIONS
A-302	STAIR DETAILS
A-501	INTERIOR ELEVATIONS
A-502	INTERIOR ELEVATIONS
A-503	
	SCHEDULES
SN1	STRUCTURAL GENERAL NOTES
S1-1.0	
S1-2.0	FLOOR FRAMING PLAN
S1-3.0	ROOF FRAMING PLAN
SD1.0	POST TENSION FOUNDATION DETAILS
SD1.1	FOUNDATION REPAIR DETAILS
SD2.0	GENERAL FRAMING DETAILS
SD3.0	ROOF FRAMING DETAILS
SD3.1	ROOF FRAMING DETAILS
SD4.0	OPEN-WEB FLOOR TRUSS DETAILS
SD4.1	OPEN-WEB FLOOR TRUSS DETAILS
M-001	SPECS, DETAILS, CALCS, SCHEDULES, LEGEND
M-101	
M-102	SECOND FLOOR MECHANICAL PLAN
E-101	SPECS, PLAN NOTES, ABBRS, SHEET INDEX,
	SYMBOL LIST & PRIOR TO COMMENCING WORK
E-102	FIRST FLOOR ELECTRICAL PLAN
E-103	SECOND FLOOR ELECTRICAL PLAN
E-104	SITE ELECTRICAL PLAN
E-105	SINGLE LINE DIAGRAM, LIGHT FIXTURES, LOAD
	CALC., PANEL SCHEDULE, FEEDER, AVAILABLE
	FAULT % VD SCHEDULE
E 100	
E-106	LOAD CALCULATIONS
	SPECS, SCHEDULE DETAIL, CALCULATIONS,
P-001	OVARDOL LEGEND & OLIFET INDEV
P-001	SYMBOL LEGEND & SHEET INDEX
P-001 P-101.1	
	FIRST FLOOR PLUMBING PLAN (WATER & GAS)
P-101.1	




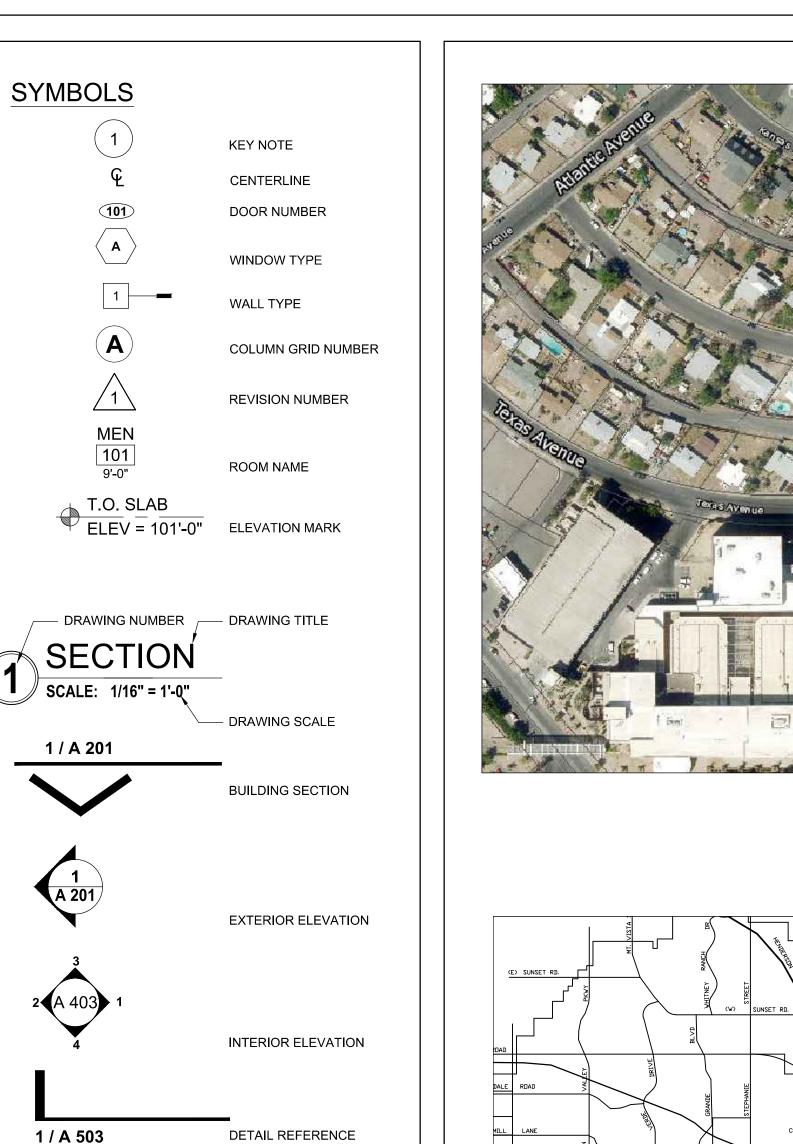





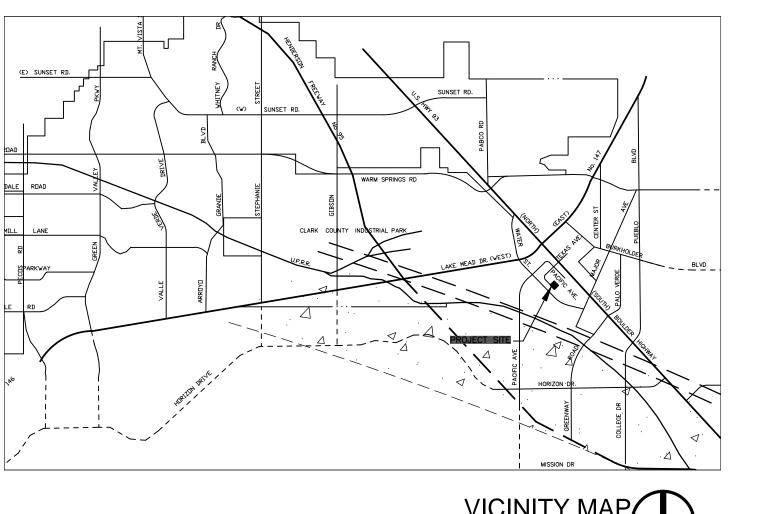

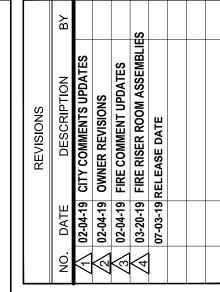




7010 Easy Wind Dr. Ste 200 Austin, TX 78752 512.899.3100

www.designopa.com


3 | ン. | LXAン ENDERSON, NEVADA 89015


PRICING SET


	the Architect, OPA Design Studio. They may not be reproduced in any form, by any method, for any purpose without previous written permission from the Architect.
I	2018 OPA Design Studio. All Rights Reserved. These designs / drawings are the sole property of

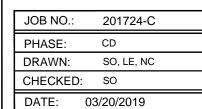

A001

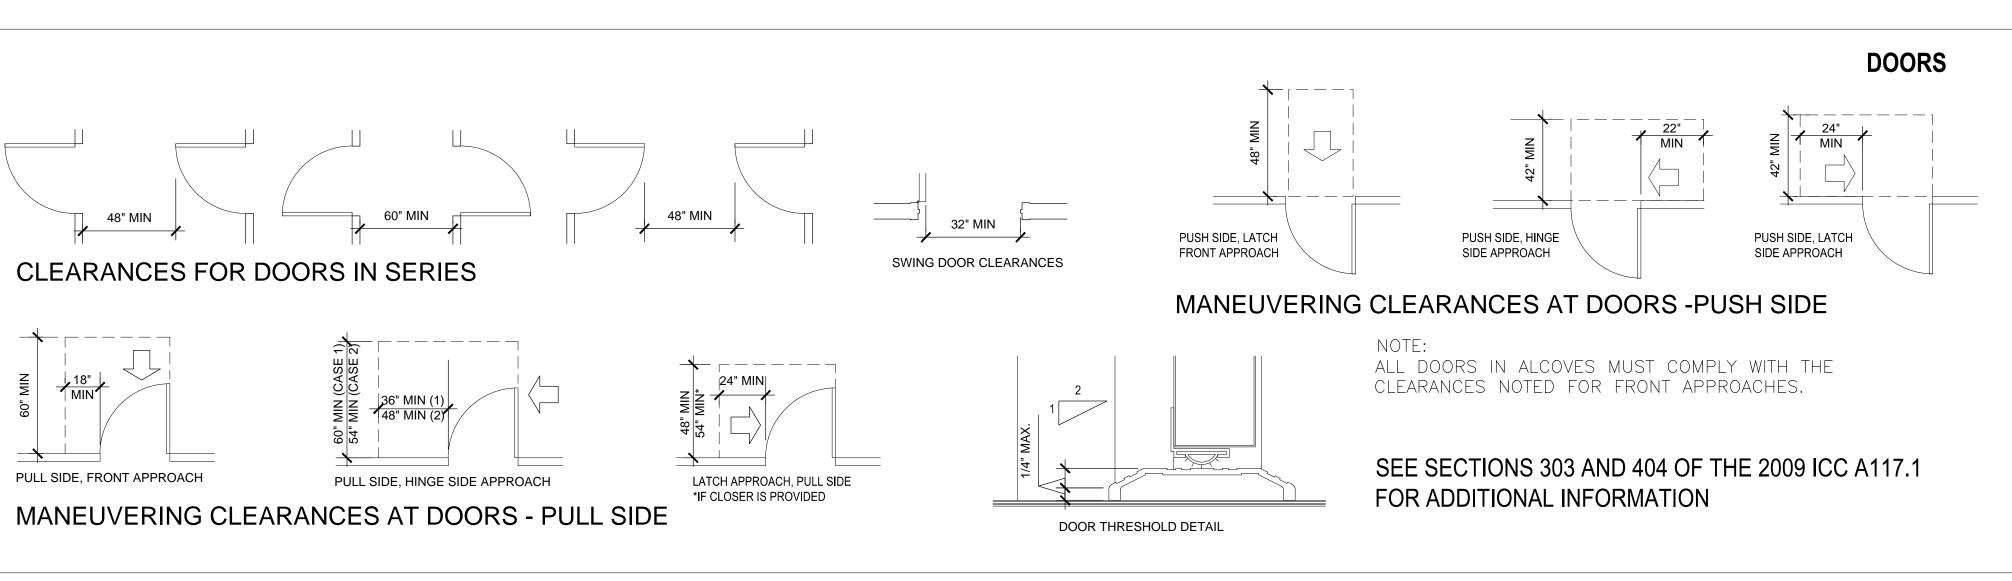

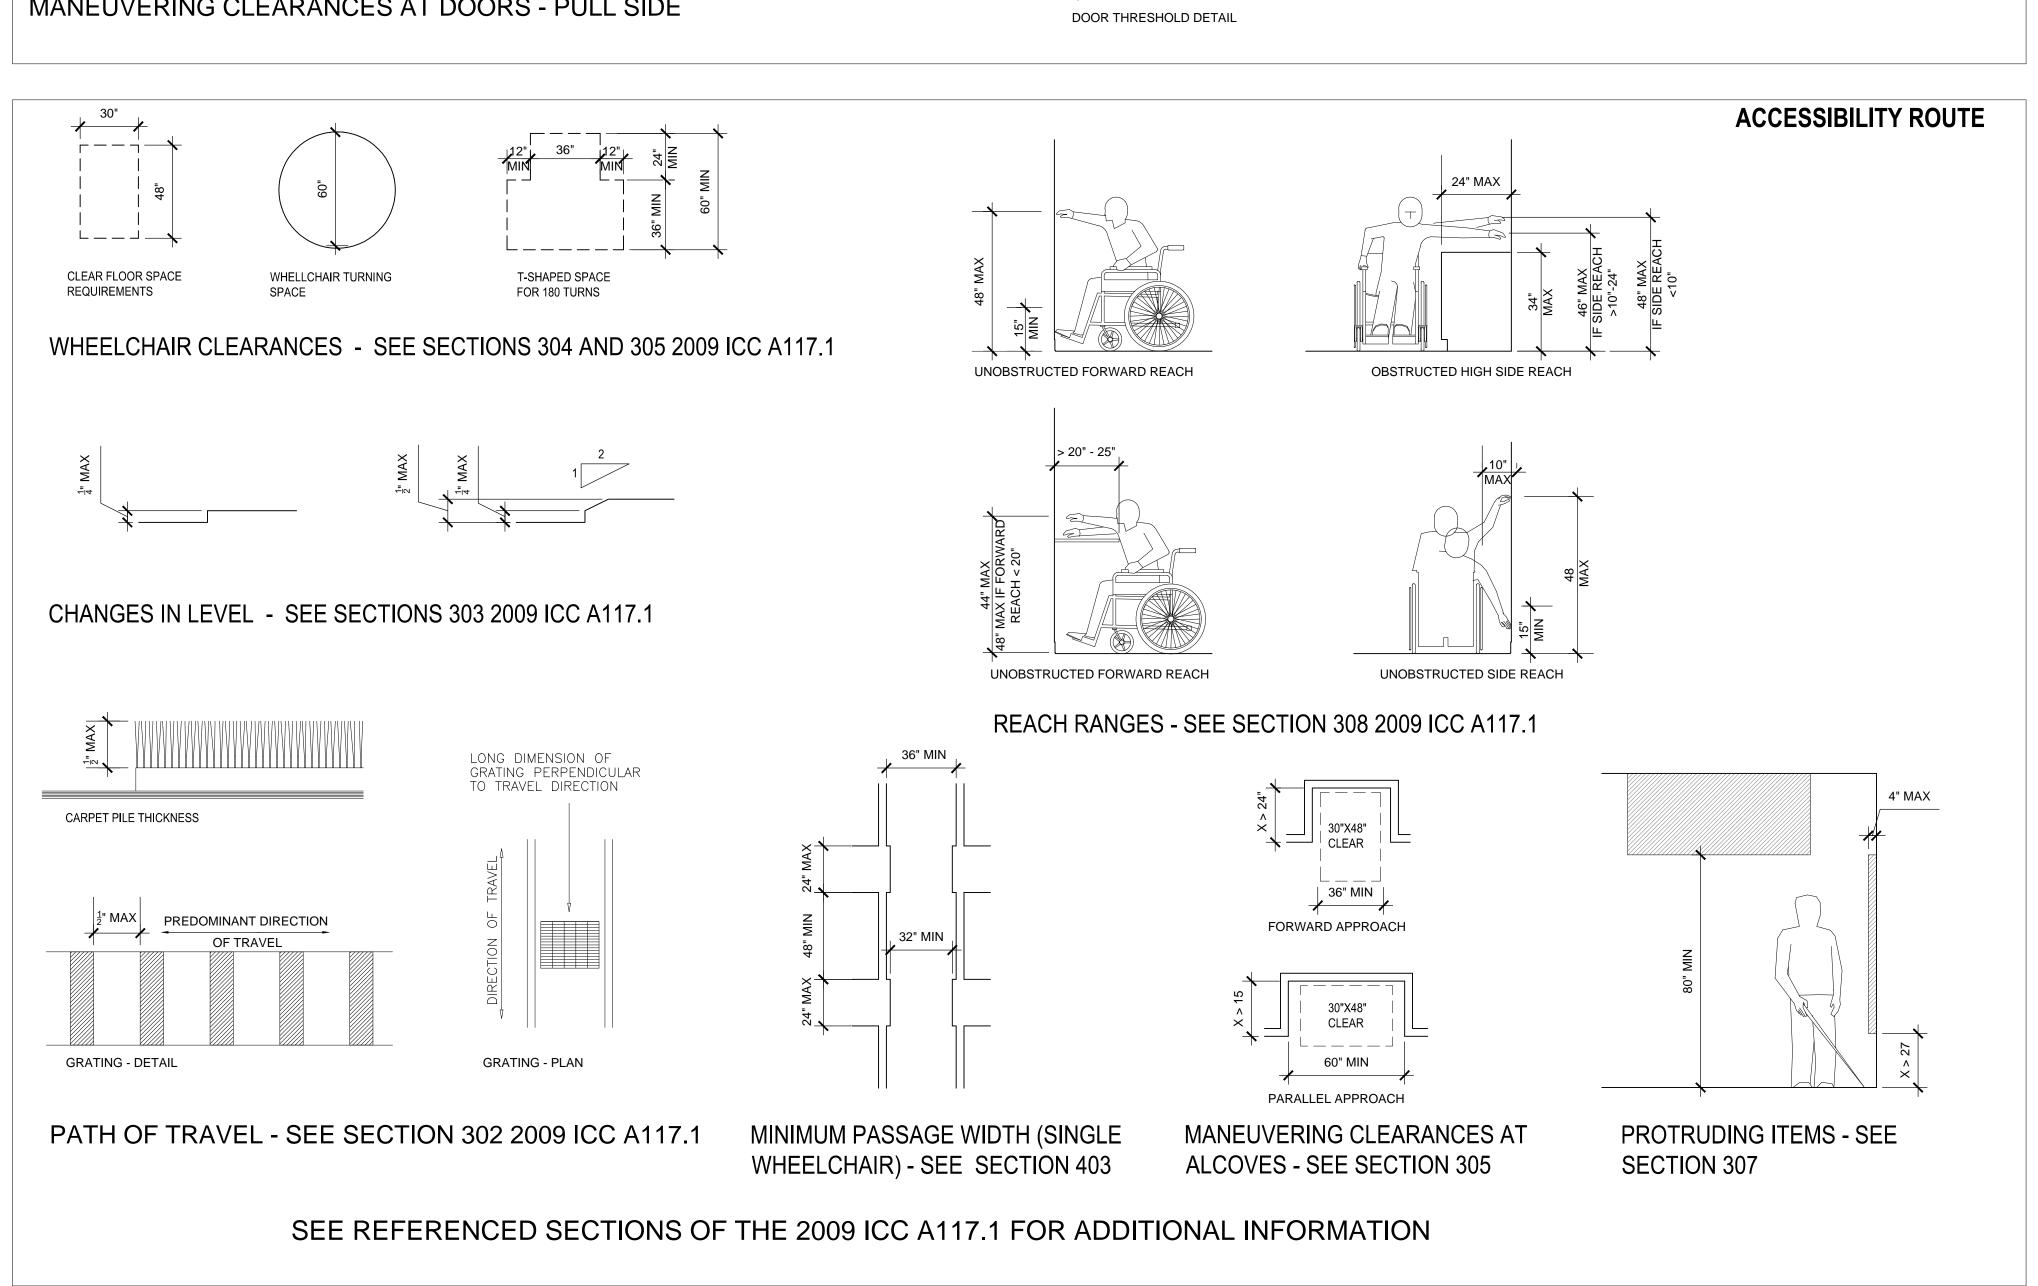

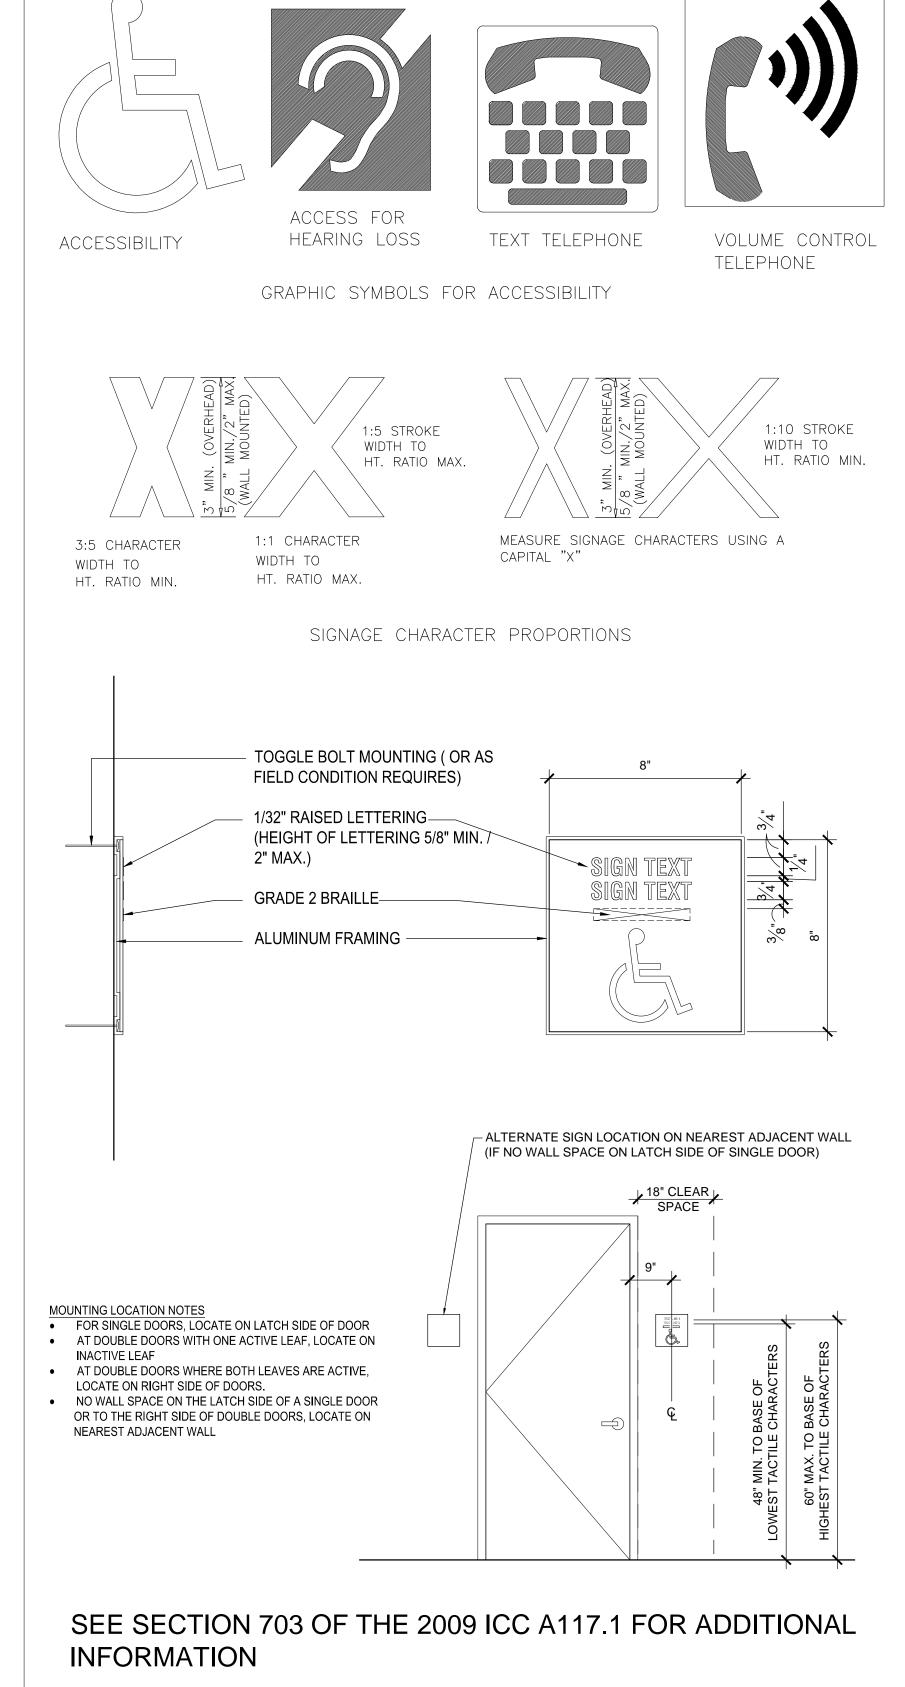

NO. DATE DESCRIPTION BY

102-04-19 CITY COMMENTS UPDATES

202-04-19 FIRE COMMENT UPDATES

302-04-19 FIRE RISER ROOM ASSEMBLIES

07-03-19 RELEASE DATE

SIGNAGE



7010 Easy Wind Dr. Ste 200 Austin, TX 78752 512.899.3100

www.designopa.com

Z57 S. IEXAS HENDERSON, NEVADA 890

2018 OPA Design Studio. All Rights Reserved. These designs / drawings are the sole property of the Architect, OPA Design Studio. They may not be reproduced in any form, by any method, for any purpose without previous written permission from the Architect.

PRICING

SET

from the Architect.

JOB NO.: 201724-C

PHASE: CD

DRAWN: SO, LE, NC

CHECKED: SO


DATE: 03/20/2019


AOO2


ADA GUIDELINES


ACCESSIBILITY NOTES:

- 1. INFORMATION SHOWN ON THESE SHEETS IS BASED ON THE 2009 ICC A117.1.
- DO NOT SCALE THESE DRAWINGS
- 3. NOT ALL CONDITIONS SHOWN ON THESE SHEETS MAY APPLY TO THIS PROJECT. COMPARE THE REQUIREMENTS OF THE ARCHITECTURAL DRAWINGS WITH THIS SHEET FOR RELEVANCE OF INFORMATION.
- DIMENSIONS INDICATED ARE MINIMUM/MAXIMUM CLEAR DIMENSIONS, MEASURED TO FINISH. CONTRACTOR IS RESPONSIBLE FOR LAYOUT OF BUILDING ELEMENTS TO ASSURE REQUIREMENTS CAN BE MET.
- NOTIFY ARCHITECT IMMEDIATELY OF ANY DISCREPANCIES BETWEEN ARCHITECTURAL DRAWINGS AND THE INFORMATION SHOWN ON THESE SHEETS.

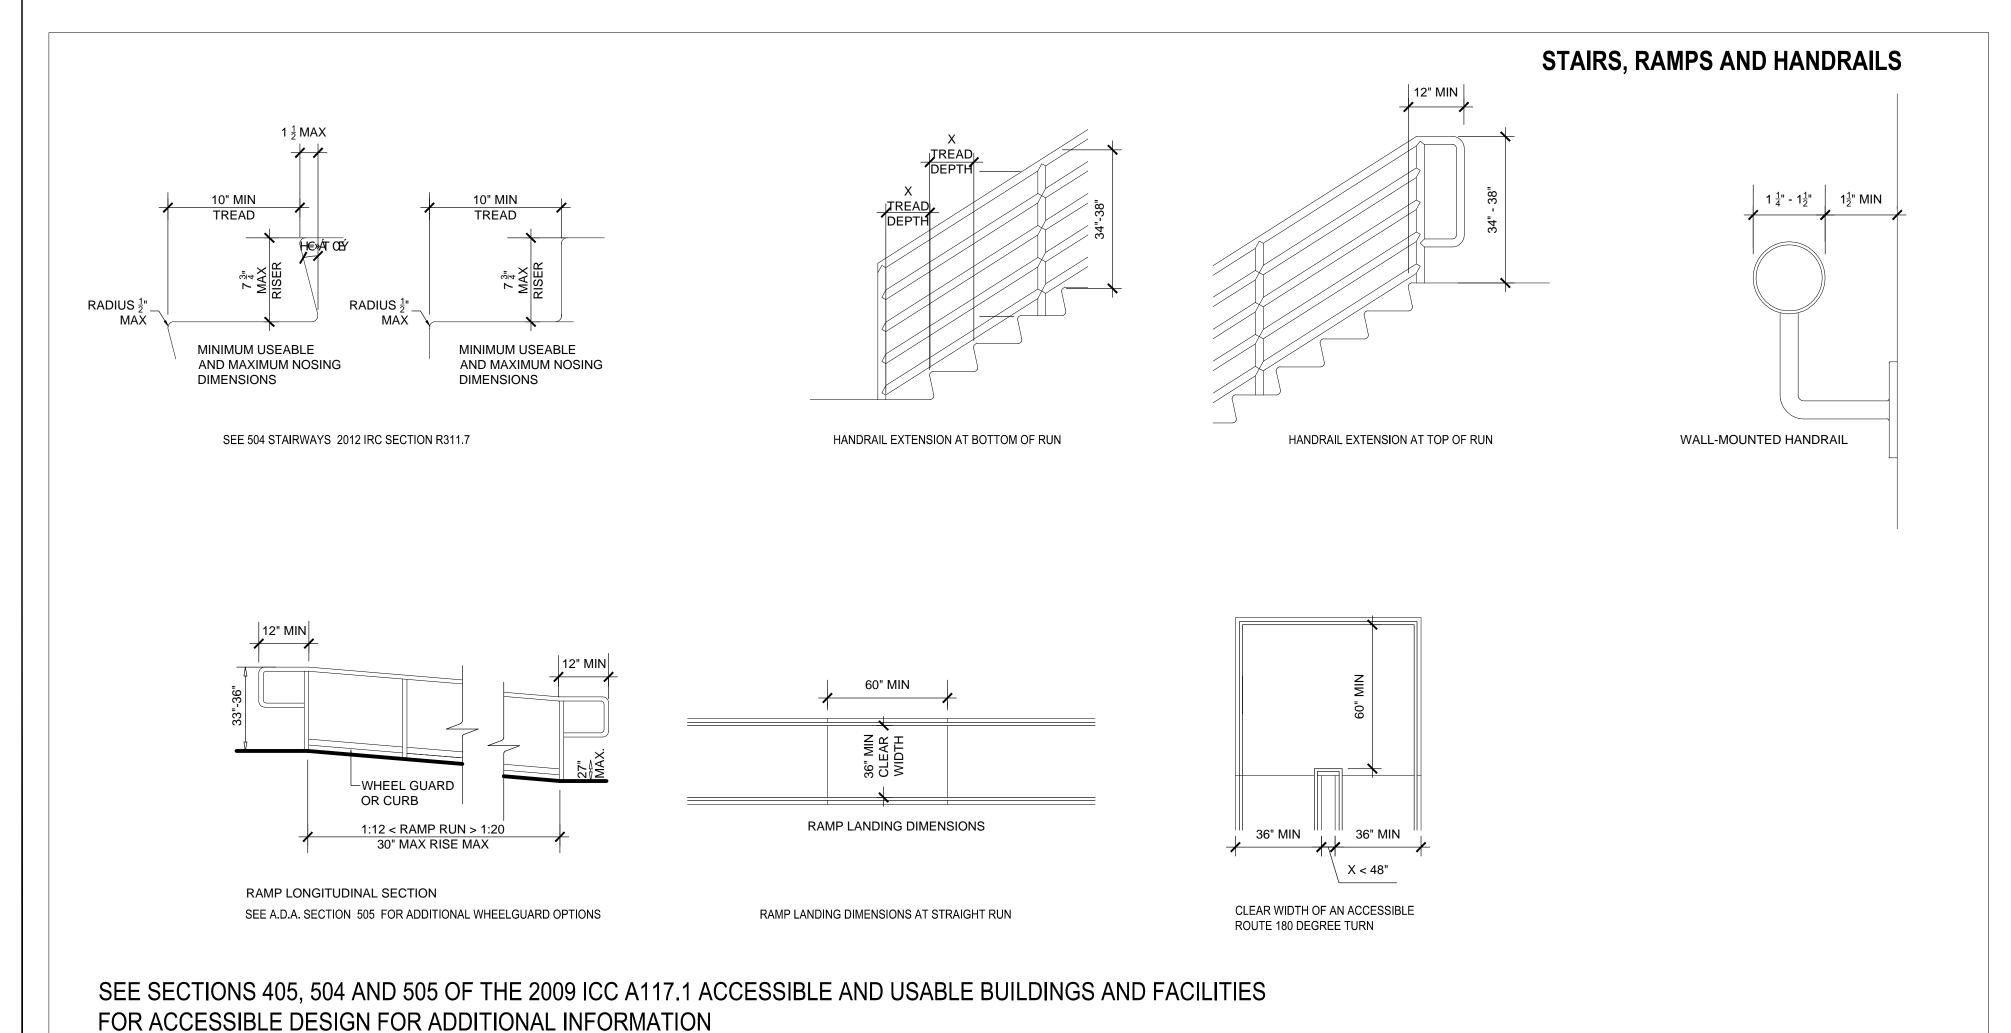

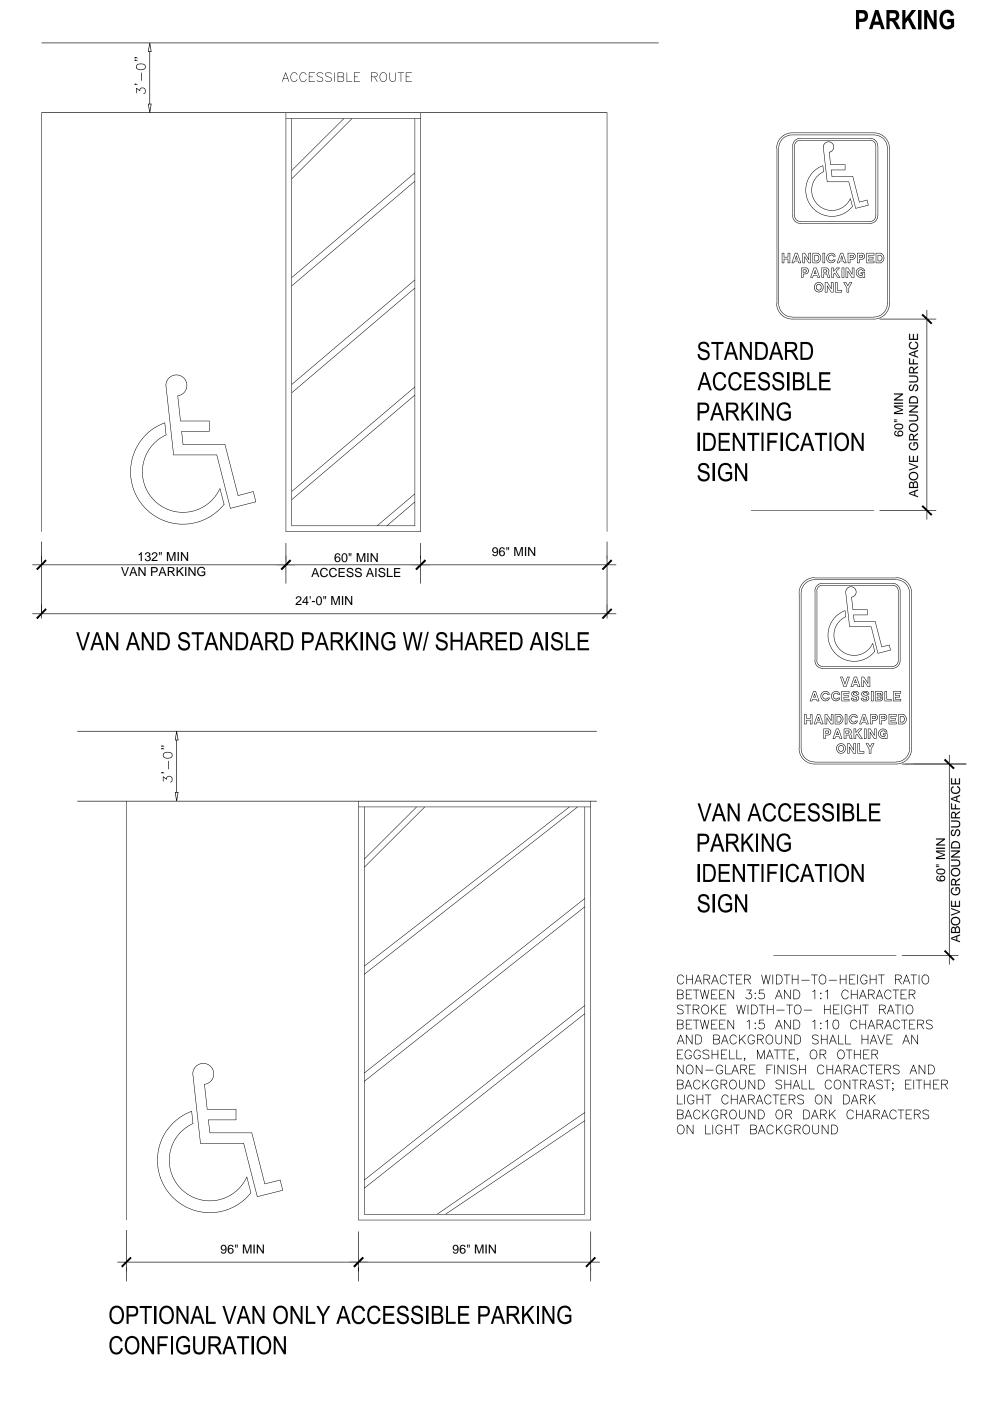

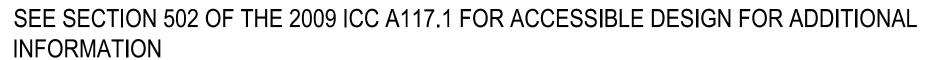

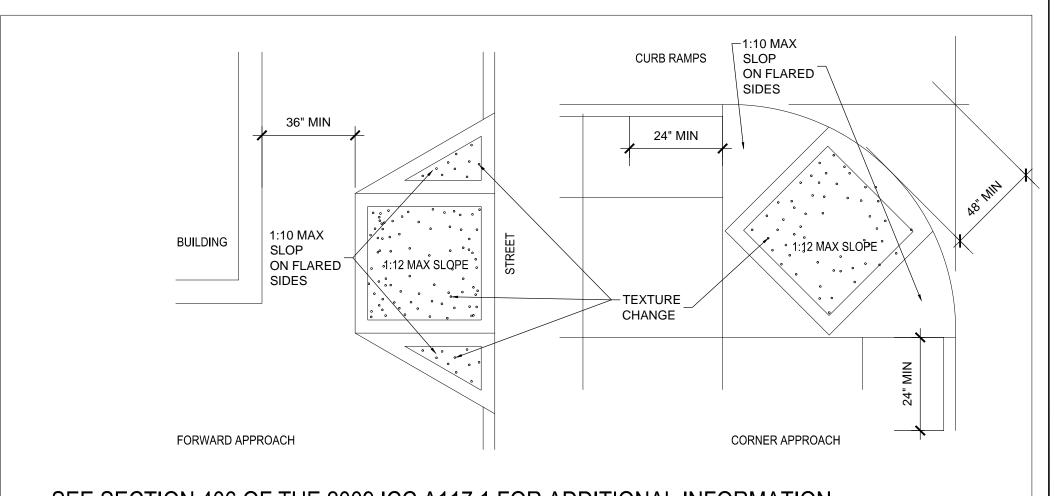

SEE SECTION 406 OF THE 2009 ICC A117.1 FOR ADDITIONAL INFORMATION



7010 Easy Wind Dr. Ste 200 Austin, TX 78752 512.899.3100

www.designopa.com

251 S. TEXAS
HENDERSON, NEVADA 89015

PRICING SET

2018 OPA Design Studio. All Rights Reserved. These designs / drawings are the sole property of the Architect, OPA Design Studio. They may not be reproduced in any form, by any method, for any purpose without previous written permission from the Architect.

JOB NO.: 201724-C


PHASE: CD

DRAWN: SO, LE, NC

CHECKED: SO

DATE: 03/20/2019

A003
ADA GUIDELINES

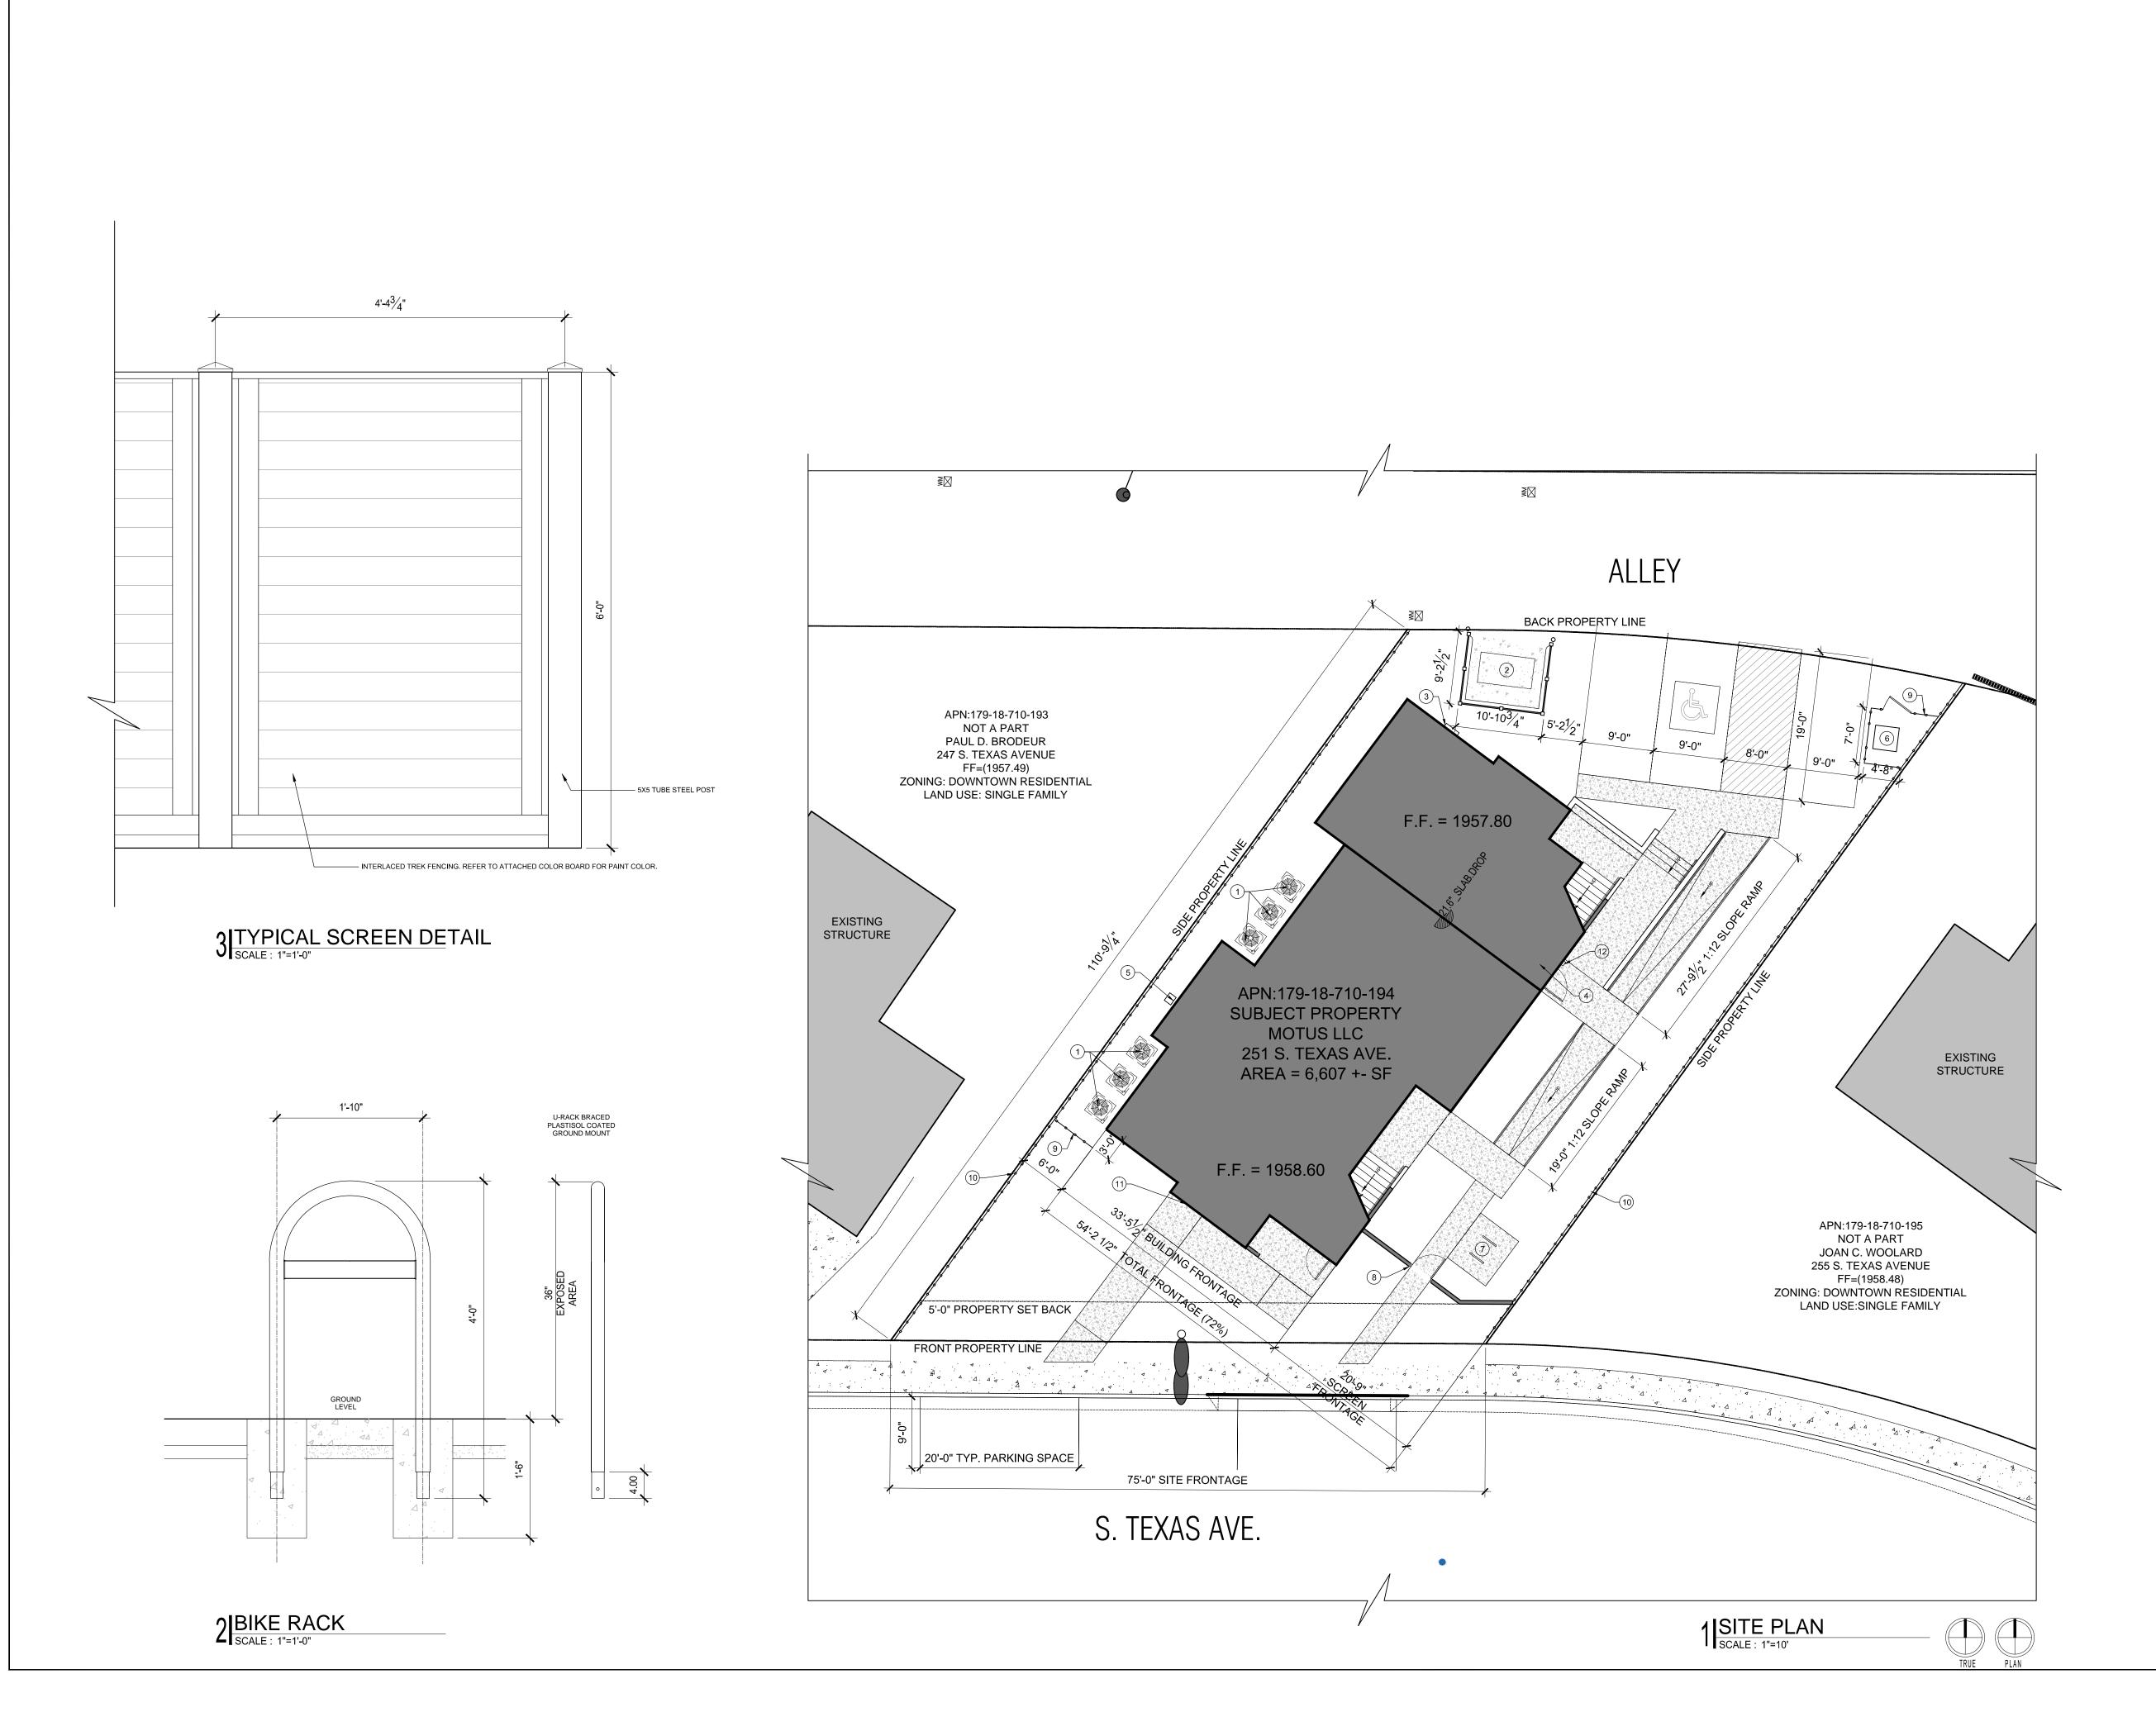

SITE PLAN GENERAL NOTES

- 1. THIS SITE PLAN IS SHOWN FOR REFERENCE ONLY. ENGINEERING SITE PLAN WILL BE SUBMITTED FOR REVIEW BY OTHERS.
- 2. ALL NEW SIDEWALKS AND PARKING SPACES TO BE "NEW GRAY CONCRETE" W/ ANSRI VALUE OF 35 PER PORTLAND CEMENT ASSOCIATION.
- 3. ALL SIDEWALKS, CURBS, STEPS, AND OFF STREET PARKING TO INCLUDE >50% CRUSHED PORTLAND CEMENT CONCRETE AS RECYCLED AGGREGATE.
- 4. IN NEW AND EXISTING BUILDING, KEYS FOR ALL LOCKABLE DOORS, EXTERIOR OR INTERIOR, UTILIZED TO ACCESS FIRE ALARM PANEL(S), MAIN FIRE SPRINKLER CONTROL VALVE(S), AND FIRE PUMP(S) SHALL BE PLACED IN THE KEY BOX. WHENEVER LOCKS ARE CHANGED, THE BUILDING OWNER OR TENANT SHALL REPLACE OLD KEYS INSIDE THE KEY BOX WITH NEW KEYS.

SITE PLAN LEGEND

PAVED ROADWAY/PARKING

SIDEWALK AND CONCRETE PADS

ADA PARKING STRIPING

DEVELOPMENT SUMMARY

OF UNITS # OF STORIES TOTAL UNIT SF: 3918 SF TOTAL BLDG. FOOTPRINT: 2297 SF BLDG. HEIGHT: 29'-10 "

.15 ACRES, 6607 SF LOT SIZE: DENSITY ON SITE:

6 UNITS / .15 ACRES FAR: 3,918 SF:6,607 SF, .59:1

ZONING INFORMATION

PARCEL #: 179-18-710-194 LOCATION: DOWNTOWN BASIC TOWNSITE NORTH AREA DR-MP-RD ZONING: DOWNTOWN EXISTING LAND USE: INVESTMENT STRATEGY

BUILDING FRONTAGE CALCULATION

BUILDING FRONTAGE ON 54'- 2 1/2" / 75'-0", 72% SOUTH TEXAS SIDE OF

BUILDING COVERAGE CALCULATION

BUILDING FOOTPRINT PERCENT OF LOT:

2,297 SF, 35%

6 SPACES

IMPERVIOUS COVERAGE CALCULATION

BUILDING FOOTPRINT: 2,297 SF, ~35% PARKING: 665 SF, ~11% WALKWAYS: 895 SF, ~14% UTILITY PADS/DUMPSTER: 206 SF, ~3% TOTAL: 4,063 SF, 62%

OPEN SPACE COVERAGE CALCULATION

TOTAL PERVIOUS COVER: 2,544 SF, 38% PARKING CALCULATION

REGULAR PARKING: **5 SPACES** ADA PARKING: 1 SPACE TOTAL PARKING: 6 SPACES

REQUIRED PARKING:



SITE PLAN KEY NOTES

- 1) A.C. UNIT, REFER TO MEP
- (2) REPUBLIC APPROVED DUMPSTER ENCLOSURE SURROUNDED BY 6'-0" TALL TRECK FENCING (3) ELECTRICAL PANEL, REFER TO MEP
- (4) FIRE RISER ROOM LOCATION
- (5) GAS METER, REFER TO MEP (6) TRANSFORMER, REFER TO MEP
- (7) TWO 2' LONG INVERTED "U" TYPE BICYCLE RACKS CONFORMING WITH COH DEV. CODE SEC. 19.7.4.K.13. EACH BIKE RACK PARKS TWO BICYCLES AND ARE ANCHORED ON
- A 6'X7' CONCRETE PAD. (8) 8'-6" TALL STUCCO WING WALL/GATE
- (9) 6'-0" TALL INTERLACED TREK FENCE SCREENING
- (10) 6'-0" TALL INTERLACED TREK FENCING ALONG PROPERTY LINE ATTACHED TO CMU RETAINING WALL PER STRUCTURAL. VERIFY LOCATION IN FIELD
- (11) BUILDING MOUNTED FIRE DEPARTMENT CONNECTION. REFER TO CIVIL ENGINEERS UTILITY PLAN (SHEET 5/7) FOR MORE INFORMATION.
- (12) KNOX BOX PROVIDED BY OWNER INSTALLED 5'-0" ABOVE FINISH FLOOR.



7010 Easy Wind Dr. Ste 200 Austin, TX 78752 512.899.3100

www.designopa.com


6

PRICING SET

2018 OPA Design Studio. All Rights Reserved. These designs / drawings are the sole property of the Architect, OPA Design Studio. They may not be reproduced in any form, by any method, for any purpose without previous written permission

JOB NO.: 201724-C

PHASE: CD DRAWN: SO, LE, NC CHECKED: SO DATE: 03/20/2019

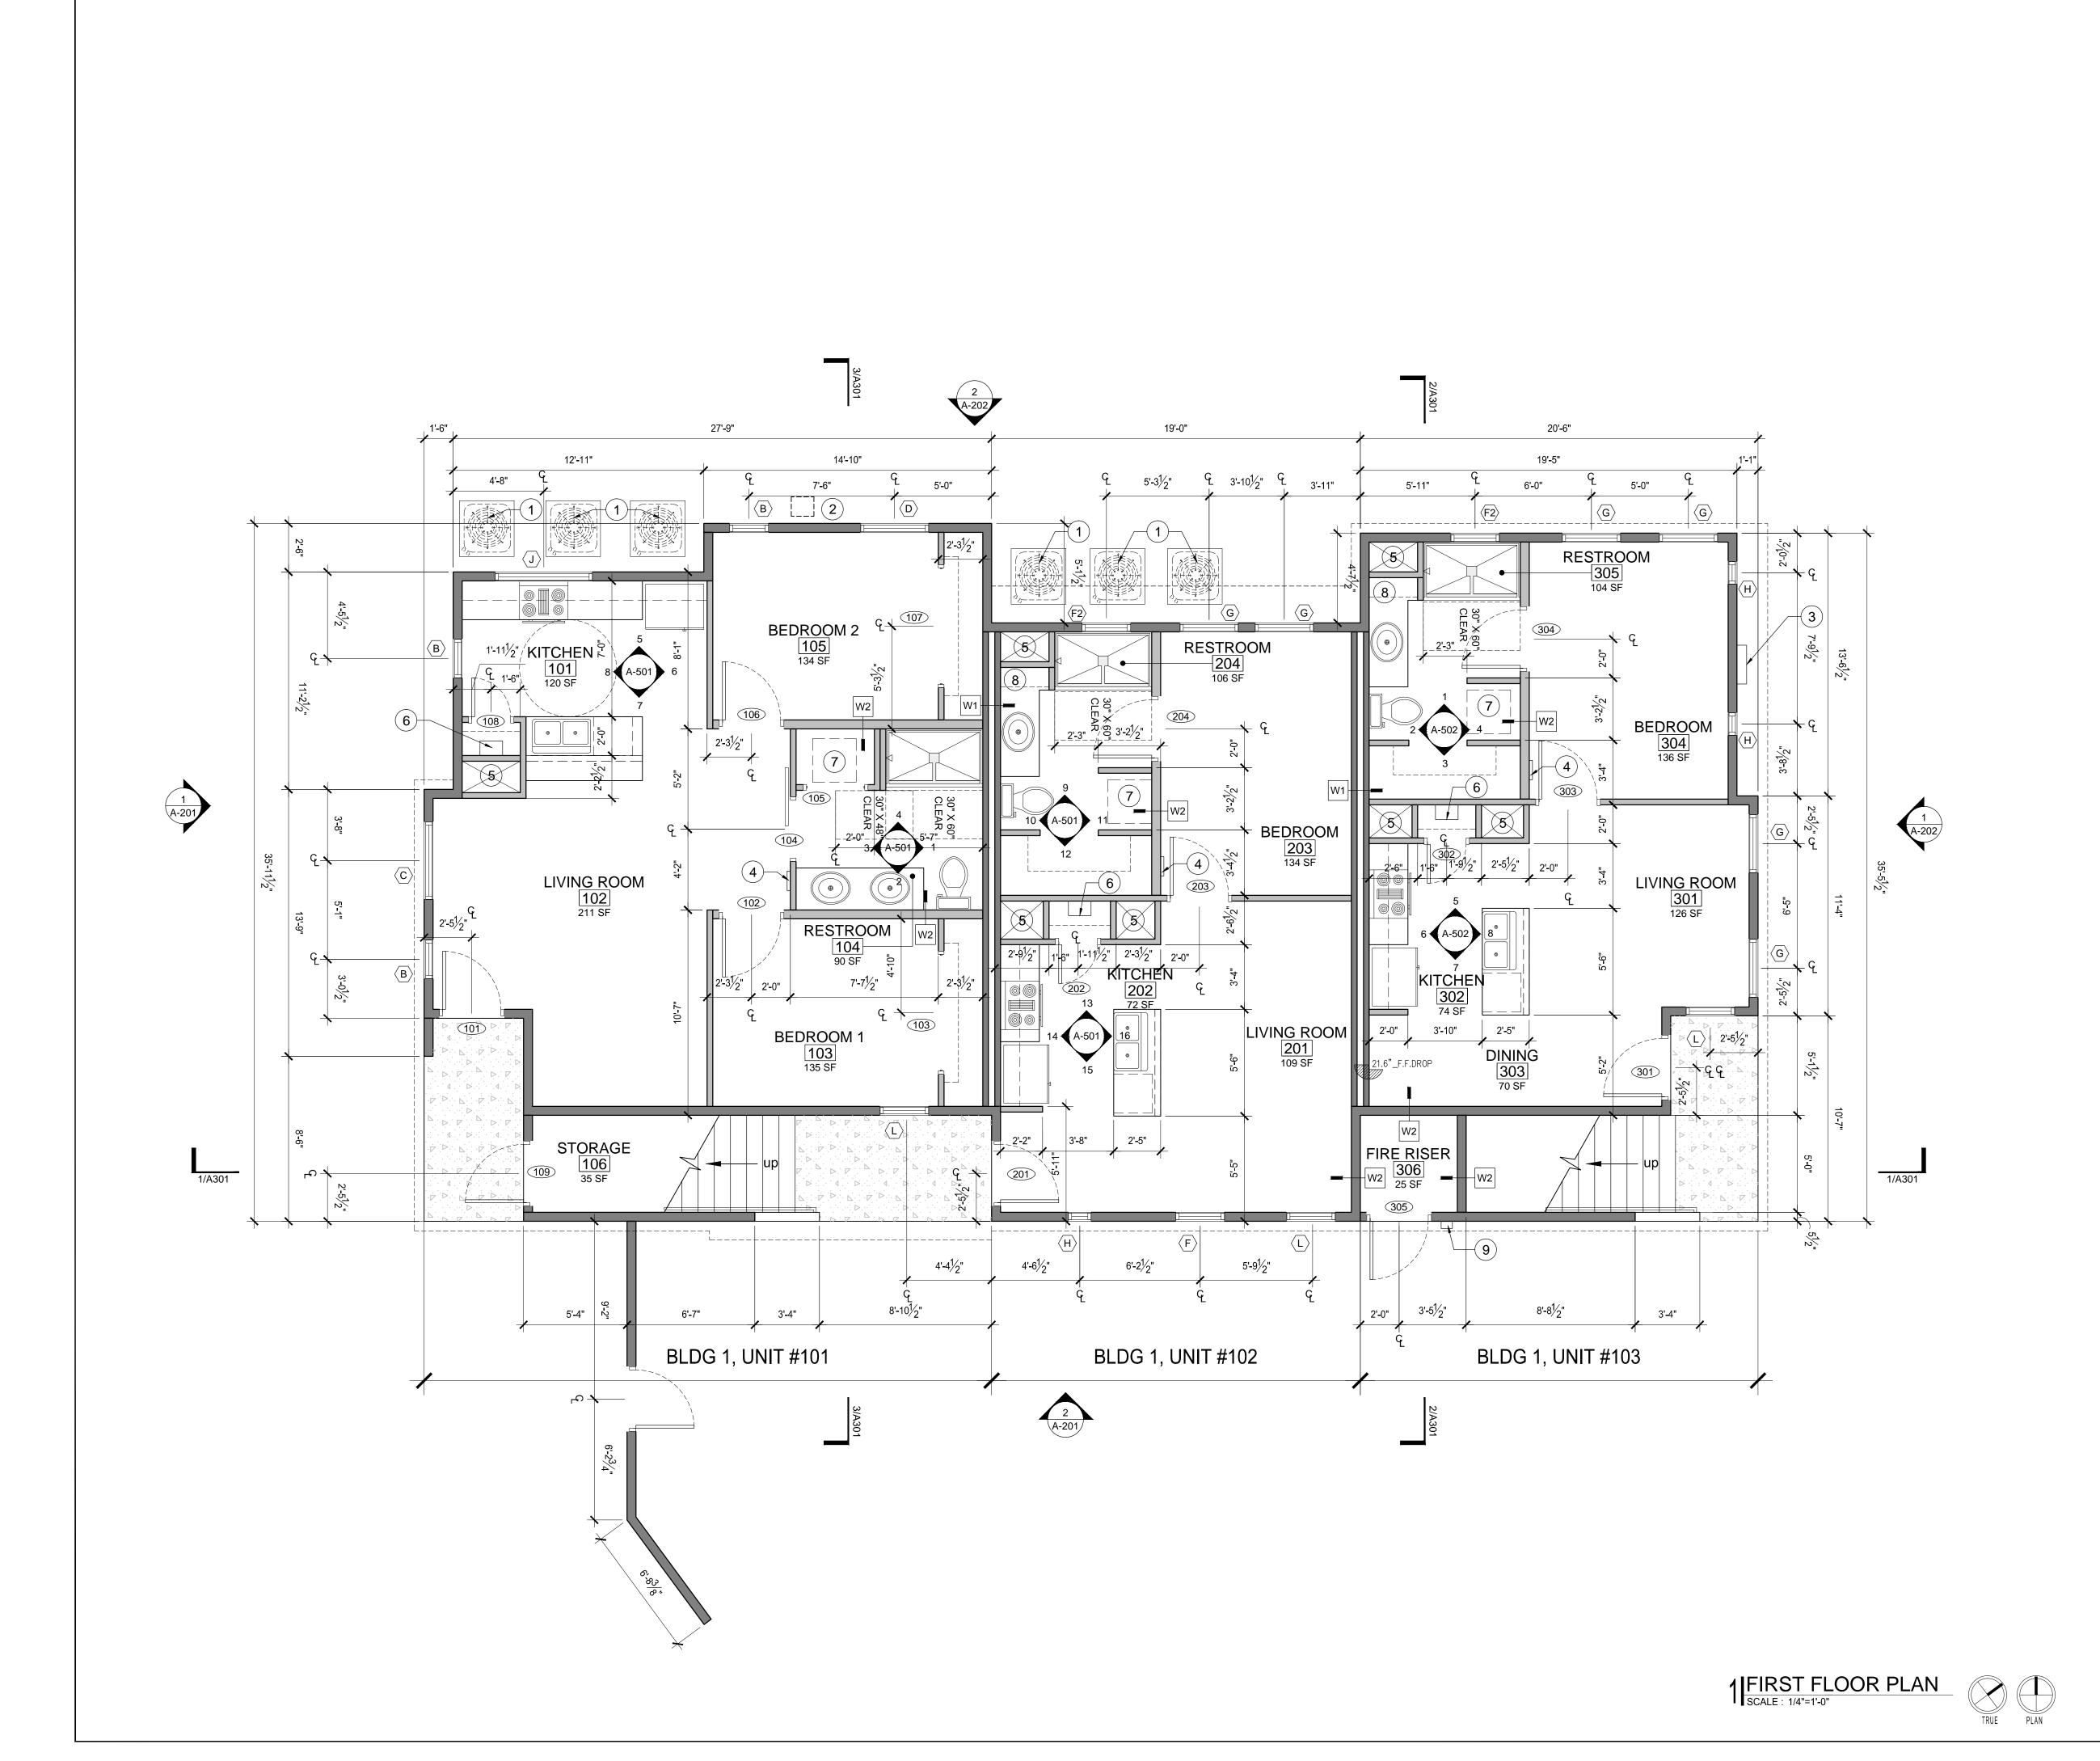



EXTERIOR WALL

INTERIOR WALL

W# WALL TYPE PER A-601

WINDOW TYPE PER A-601 DOOR TYPE PER A-601

FLOOR PLAN KEYNOTE EXTERIOR ENTRY LANDING

FLOOR PLAN GENERAL NOTES:

- DIMENSIONS ARE TO FACE OF STUD UNLESS NOTED OTHERWISE.
- 2. THIS DESIGN ASSUMES 6" WOOD STUDS AT BUILDING PERIMETER WITH R19 BATT INSULATION. "LINE OF STRUCTURE" REFERS TO OUTSIDE EDGE OF STRUCTURE/INSIDE FACE OF PERIMETER STUDS.
- 3. THE CONTRACTOR IS RESPONSIBLE FOR VERIFYING ALL DIMENSIONS, SITE GRADES, ETC., PRIOR TO CONSTRUCTION AND NOTIFY THE ARCHITECT OF ANY DISCREPANCIES THAT COULD AFFECT THE DESIGN AND FINISH-OUT OF THE BUILDING. SITE LAYOUT TO BE VERIFIED BY A LICENSED SURVEYOR WITH WRITTEN VERIFICATION FORWARDED TO THE OWNER/ARCHITECT.
- 4. THE CONTRACTOR IS RESPONSIBLE FOR COORDINATING THE WORK OF ALL UTILITY COMPANIES AND PERFORMING ALL WORK REQUIRED FOR UTILITIES.
- THE OWNER SHALL PAY AND OBTAIN ALL REQUIRED PERMITS AND CERTIFICATES FOR DEMOLITION. THE CONTRACTOR SHALL BE RESPONSIBLE FOR ALL UTILITY FEES AND PERMITS. 6. ANY FIELD CONDITIONS NOT CALLED OUT ON THE

ARCHITECTURAL PLANS ARE TO BE COORDINATED WITH

- THE CONTRACTOR, ARCHITECT AND OWNER AND OTHERS AS NECESSARY IN THE FIELD. CONTRACTOR SHALL NOTIFY THE ARCHITECT OF ANY DISCREPANCIES IN THE DRAWINGS AND ACTUAL FIELD
- CONDITIONS PRIOR TO START OF WORK. B. CONTRACTOR SHALL BE RESPONSIBLE FOR ALL DAMAGE TO THE EXISTING PROPERTY, BUILDINGS OR OWNER'S EQUIPMENT INCURRED BY HIS STAFF OR

SUBCONTRACTORS.

- 9. THE ARCHITECT WILL NOT BE RESPONSIBLE FOR, NOR HAVE CONTROL OF, NOR BE IN CHARGE OF CONSTRUCTION MEANS, METHODS, TECHNIQUES, SEQUENCES OR PROCEDURES, NOR FOR SAFETY PRECAUTIONS AND PROGRAMS IN CONNECTION WITH THE WORK, AND WILL NOT BE RESPONSIBLE FOR THE CONTRACTOR'S FAILURE TO CARRY OUT THE WORK.
- 10. UNITS TO BE SEPARATED BY 1 HOUR FIRE BARRIERS AT WALLS AND FLOOR STRUCTURE.
- 11. ALL INTERIOR WALLS NOT NOTED WITH WALL TAG IS 2X4 WOOD WALL WITH OUT FIRE BARRIER REQTS.
- 12. IN NEW AND EXISTING BUILDING, KEYS FOR ALL LOCKABLE DOORS, EXTERIOR OR INTERIOR, UTILIZED TO ACCESS FIRE ALARM PANEL(S), MAIN FIRE SPRINKLER CONTROL VALVE(S), AND FIRE PUMP(S) SHALL BE PLACED IN THE KEY BOX. WHENEVER LOCKS ARE CHANGED, THE BUILDING OWNER OR TENANT SHALL REPLACE OLD KEYS INSIDE THE KEY BOX WITH NEW KEYS.
- 13. FIRE RISER ROOM ACCESS DOOR SHALL BE LABELED WITH WEATHERPROOF SIGN STATING "FIRE SPRINKLER ROOM" IN COMPLIANCE WITH IFC 2012 916.10 SIGNAGE. LETTERING SHALL BE A MINIMUM OF 2" IN HEIGHT AND WITH A MINIMUM STROKE OF 3/8".


AREA CALCULATIONS

BLDG 1, UNIT #101	761 SF	2 BEDROOM
BLDG 1, UNIT #102	564 SF	1 BEDROOM
BLDG 1, UNIT #103	558 SF	1 BEDROOM
BLDG 1, UNIT #201	857 SF	2 BEDROOM
BLDG 1, UNIT #202	563 SF	1 BEDROOM
BLDG 1, UNIT #203	615 SF	1 BEDROOM

TOTAL: 3918 SF 8 BEDROOMS

FLOOR PLAN KEYNOTES

- 1 A.C. UNIT
- (2) GAS METER (3) ELECTRICAL PANEL
- (4) SUB PANEL
- (5) UTILITY CHASE
- 6 TANKLESS WATER HEATER 7 STACKED WASHER/DRYER
- 8 MILLWORK CABINET
- (9) KNOX BOX PROVIDED BY OWNER INSTALLED 5'-0" ABOVE FINISH FLOOR.

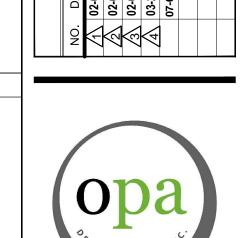

7010 Easy Wind Dr. Ste 200 Austin, TX 78752 512.899.3100

www.designopa.com

890


2018 OPA Design Studio. All Rights Reserved. These designs / drawings are the sole property of the Architect, OPA Design Studio. They may not be reproduced in any form, by any method, for any purpose without previous written permission

PRICING

SET

JOB NO.: 201724-C PHASE: CD DRAWN: SO, LE, NC CHECKED: SO DATE: 03/20/2019

FIRST FLOOR PLAN

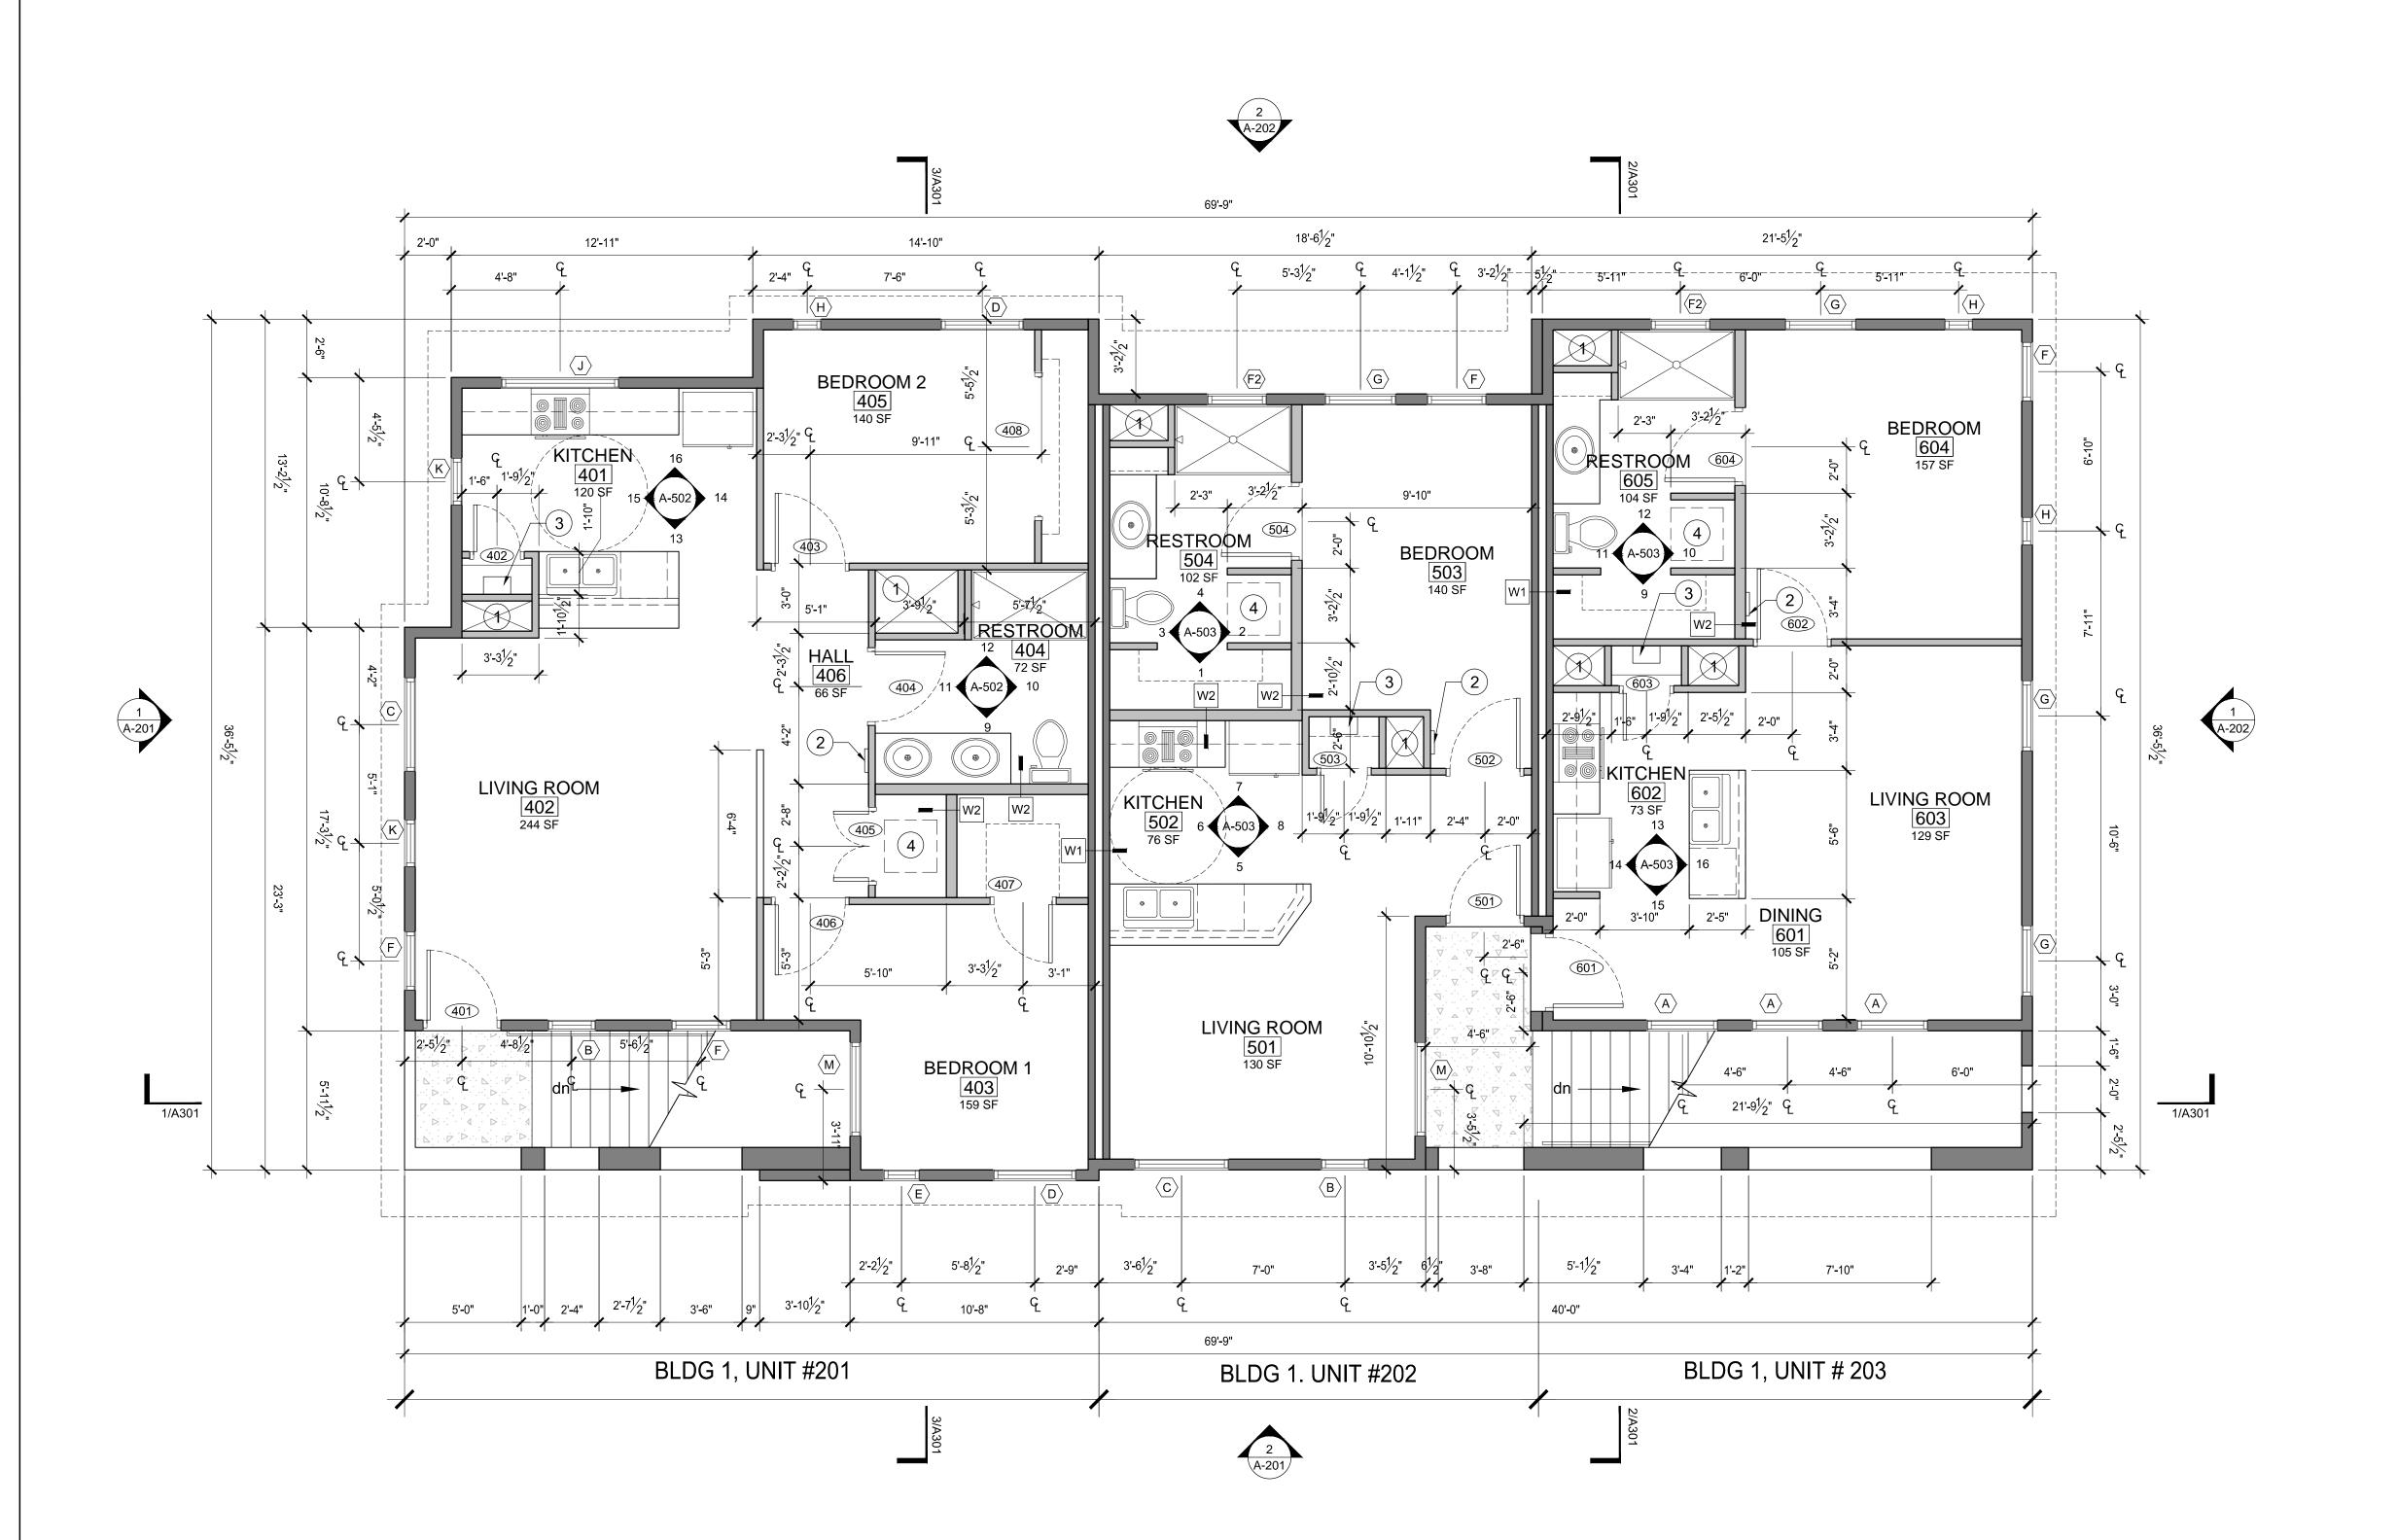

LEGEND

EXTERIOR WALL INTERIOR WALL

W# WALL TYPE PER A-601

WINDOW TYPE PER A-601 # DOOR TYPE PER A-601

FLOOR PLAN KEYNOTE

EXTERIOR ENTRY LANDING

FLOOR PLAN GENERAL NOTES:

- DIMENSIONS ARE TO FACE OF STUD UNLESS NOTED OTHERWISE.
- THIS DESIGN ASSUMES 6" WOOD STUDS AT BUILDING PERIMETER WITH R19 BATT INSULATION. "LINE OF STRUCTURE" REFERS TO OUTSIDE EDGE OF STRUCTURE/INSIDE FACE OF PERIMETER STUDS.
- THE CONTRACTOR IS RESPONSIBLE FOR VERIFYING ALL DIMENSIONS, SITE GRADES, ETC., PRIOR TO CONSTRUCTION AND NOTIFY THE ARCHITECT OF ANY DISCREPANCIES THAT COULD AFFECT THE DESIGN AND FINISH-OUT OF THE BUILDING. SITE LAYOUT TO BE VERIFIED BY A LICENSED SURVEYOR WITH WRITTEN VERIFICATION FORWARDED TO THE OWNER/ARCHITECT.
- THE CONTRACTOR IS RESPONSIBLE FOR COORDINATING THE WORK OF ALL UTILITY COMPANIES AND PERFORMING ALL WORK REQUIRED FOR UTILITIES.
- THE OWNER SHALL PAY AND OBTAIN ALL REQUIRED PERMITS AND CERTIFICATES FOR DEMOLITION. THE CONTRACTOR SHALL BE RESPONSIBLE FOR ALL UTILITY FEES AND PERMITS.
- ANY FIELD CONDITIONS NOT CALLED OUT ON THE ARCHITECTURAL PLANS ARE TO BE COORDINATED WITH THE CONTRACTOR, ARCHITECT AND OWNER AND OTHERS AS NECESSARY IN THE FIELD. CONTRACTOR SHALL NOTIFY THE ARCHITECT OF ANY

DISCREPANCIES IN THE DRAWINGS AND ACTUAL FIELD

- CONDITIONS PRIOR TO START OF WORK. CONTRACTOR SHALL BE RESPONSIBLE FOR ALL DAMAGE TO THE EXISTING PROPERTY, BUILDINGS OR OWNER'S EQUIPMENT INCURRED BY HIS STAFF OR
- THE ARCHITECT WILL NOT BE RESPONSIBLE FOR, NOR HAVE CONTROL OF, NOR BE IN CHARGE OF CONSTRUCTION MEANS, METHODS, TECHNIQUES, SEQUENCES OR PROCEDURES, NOR FOR SAFETY PRECAUTIONS AND PROGRAMS IN CONNECTION WITH THE WORK, AND WILL NOT BE RESPONSIBLE FOR THE CONTRACTOR'S FAILURE TO CARRY OUT THE WORK.
- 10. UNITS TO BE SEPARATED BY 1 HOUR FIRE BARRIERS AT WALLS AND FLOOR STRUCTURE.
- 11. ALL INTERIOR WALLS NOT NOTED WITH WALL TAG IS 2X4 WOOD WALL WITH OUT FIRE BARRIER REQTS.

AREA CALCULATIONS

SUBCONTRACTORS.

BLDG 1, UNIT #101 761 SF 2 BEDROOM BLDG 1, UNIT #102 1 BEDROOM BLDG 1, UNIT #201 857 SF 2 BEDROOM BLDG 1, UNIT #202 563 SF 1 BEDROOM BLDG 1, UNIT #203 615 SF 1 BEDROOM

3918 SF 8 BEDROOMS TOTAL:

FLOOR PLAN KEYNOTES

- (1) UTILITY CHASE
- (2) SUB PANEL
- (3) TANKLESS WATER HEATER (4) STACKED WASHER/DRYER

7010 Easy Wind Dr. Ste 200 Austin, TX 78752 512.899.3100

www.designopa.com

89


PRICING SET

These designs / drawings are the sole property of the Architect, OPA Design Studio. They may not be reproduced in any form, by any method, for any purpose without previous written permission

JOB NO.: 201724-C DRAWN: SO, LE, NC CHECKED: SO DATE: 03/20/2019

2ND FLOOR PLAN

1|SECOND FLOOR PLAN

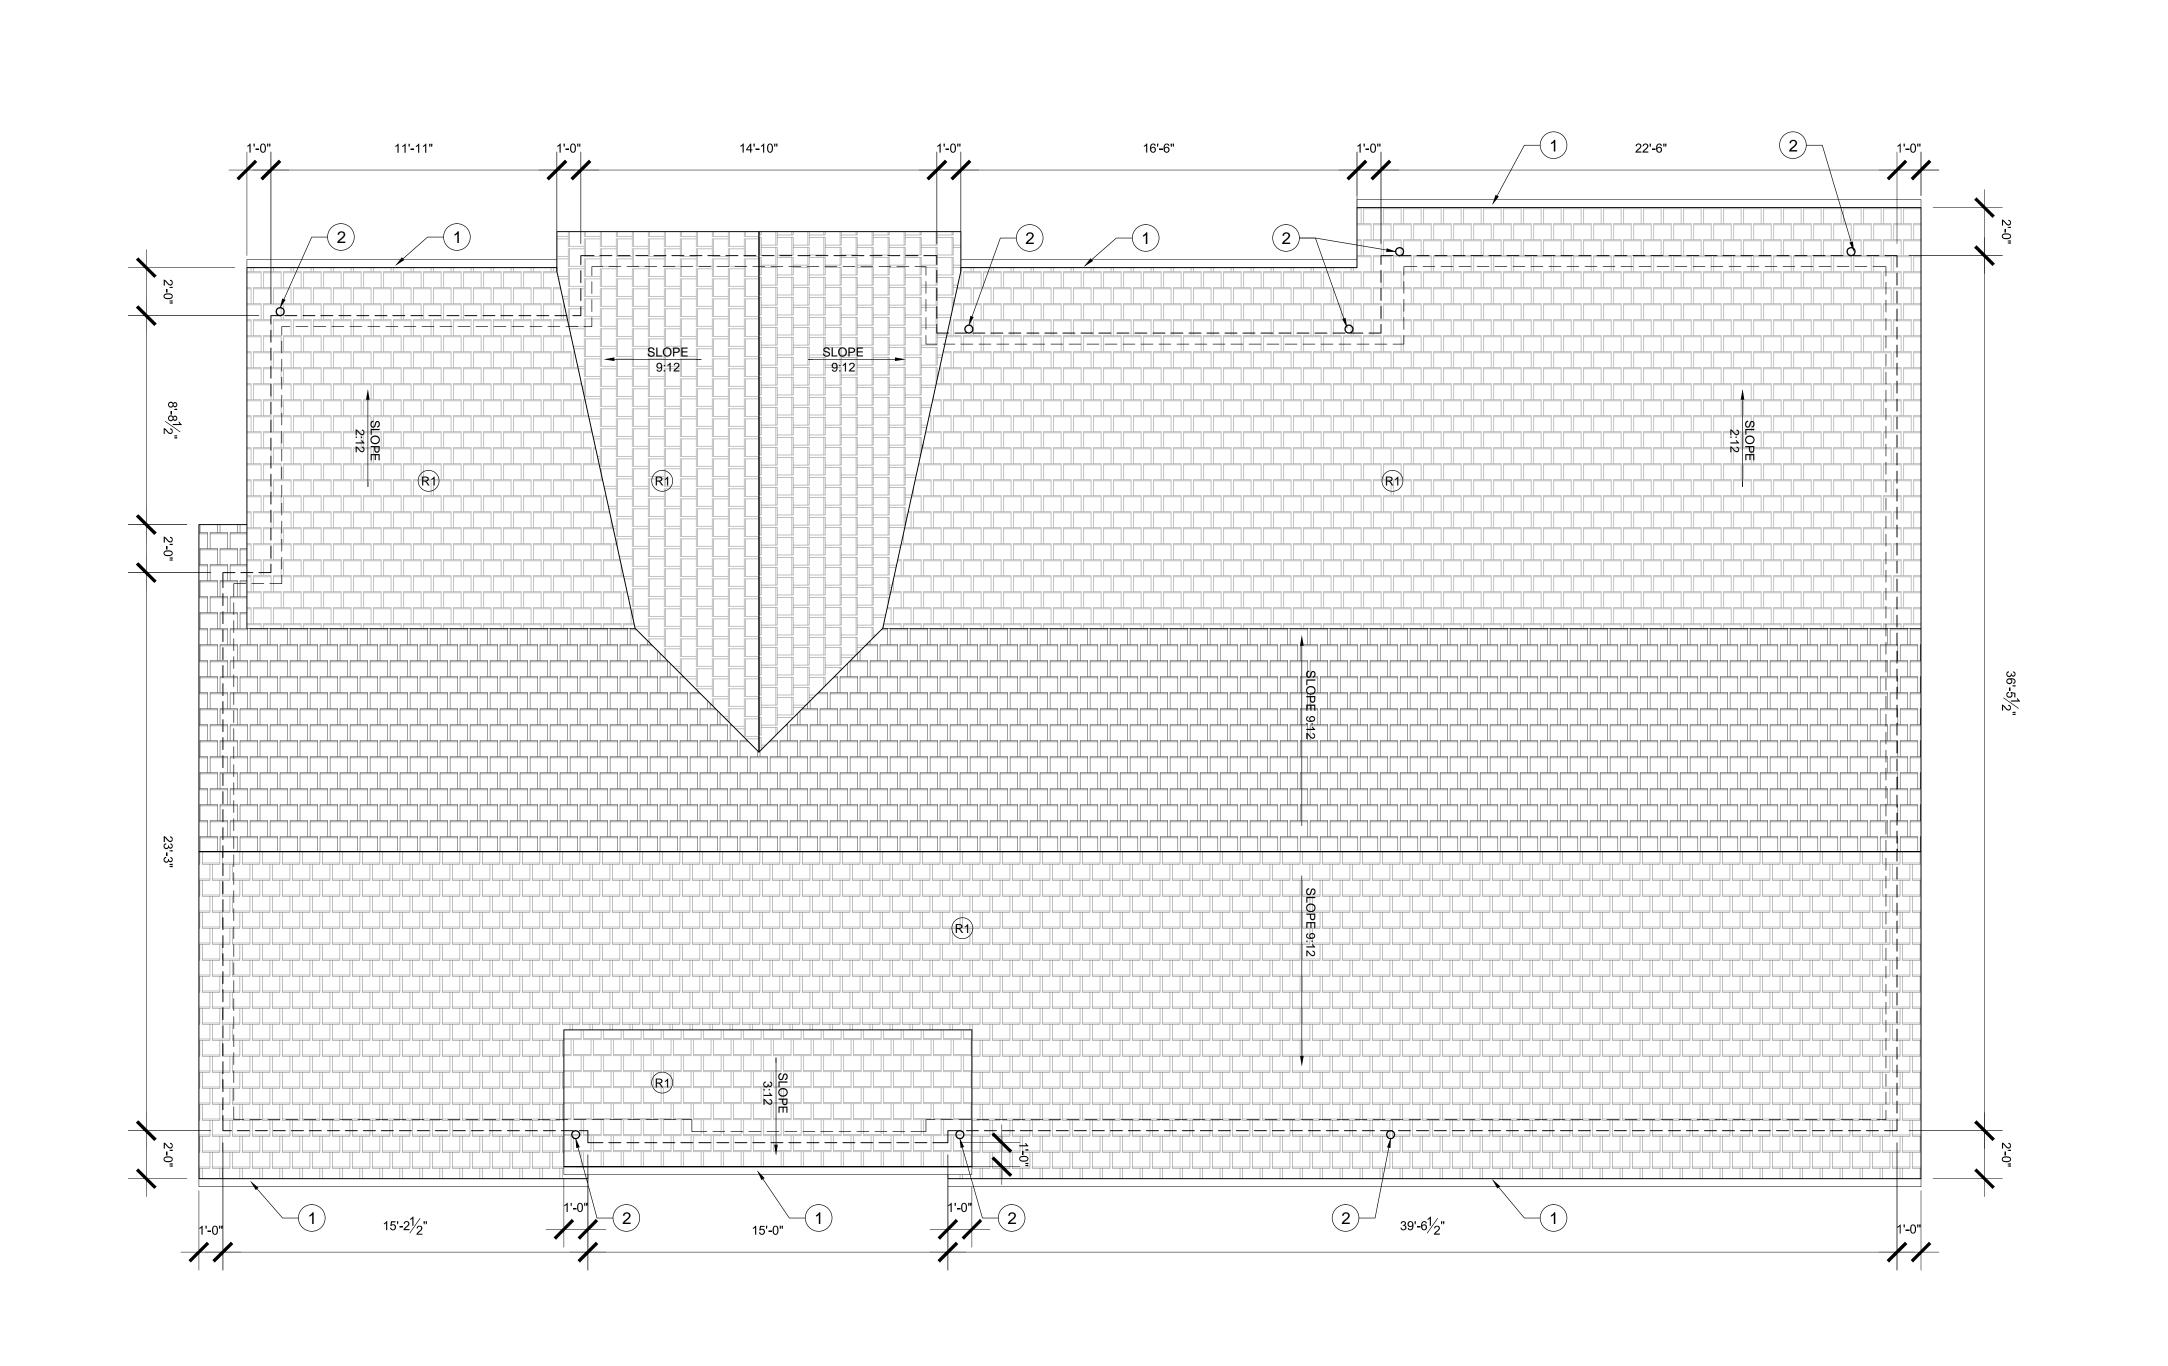

ROOF ASSEMBLIES

R1) ASPHALT SHINGLE

ROOF PLAN GENERAL NOTES:

- 1. MANUFACTURER'S REP TO INSPECT ALL ROOFING APPLICATIONS TO ENSURE ADHERENCE TO MFG. GUIDELINES AND CERTIFY TO THE GENERAL CONTRACTOR THAT ROOF IS INSTALLED PER MFG. GUIDELINES.
- 2. ROOF PENETRATIONS SHOWN ARE SCHEMATIC IN NATURE AND FOR THE CONVENIENCE OF THE CONTRACTOR. GENERAL CONTRACTOR RESPONSIBLE FOR MAKING FINAL COORDINATION OF SIZE, TYPE AND LOCATION OF CURBS (WHERE APPLICABLE) AND ANY OTHER ROOF PENETRATIONS THAT MAY BE REQUIRED
- 3. SEE MEP DRAWINGS FOR ROOF MOUNTED EQUIPMENT (WHERE APPLICABLE) AND PENETRATIONS, MAINTAIN ENGINEER'S MINIMUM REQUIREMENTS FROM VENTS TO AIR INTAKES.


AT NO ADDITIONAL COST TO THE OWNER.

- 4. ALL ROOFING DETAILS SHALL COMFORM WITH "SMACNA" AND "NRCA" REQUIREMENTS.
- 5. PROVIDE ROOF ACCESS WITH REQUIRED SAFETY STANDARDS AND ROOF WALKING PADS TO ALL EQUIPMENT (WHERE APPLICABLE).
- 6. ALL DOWNSPOUTS TO BE 5" GALVANIZED ROUND UNLESS NOTED OTHERWISE, VERIFY DOWNSPOUT SIZE AND LOCATIONS WITH FINAL ROOF RAINWATER CALCULATION AND ARCHITECT. WHERE NOTED, CONNECT DOWNSPOUTS TO STORM WATER DRAIN SYSTEM, REFER TO CIVIL.
- 7. DOWNSPOUT TERMINATION NOT CONNECTED TO STORM WATER DRAIN SYSTEM TO BE STRAIGHT SHAFT TYPE WITH KICK-OUT AND SPLASHBLOCK.

ROOF PLAN KEYNOTES

1) 4" GUTTER (2) DOWNSPOUT

(3) ROOF VENT. REFER TO MEP.

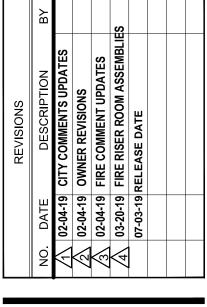



7010 Easy Wind Dr. Ste 200 Austin, TX 78752 512.899.3100

www.designopa.com

890

1 ROOF PLAN
SCALE: 1/4"=1'-0"

CHECKED: SO DATE: 03/20/2019


JOB NO.: 201724-C

DRAWN: SO, LE, NC

PRICING

SET

2018 OPA Design Studio. All Rights Reserved. These designs / drawings are the sole property of the Architect, OPA Design Studio. They may not be reproduced in any form, by any method, for any purpose without previous written permission from the Architect.

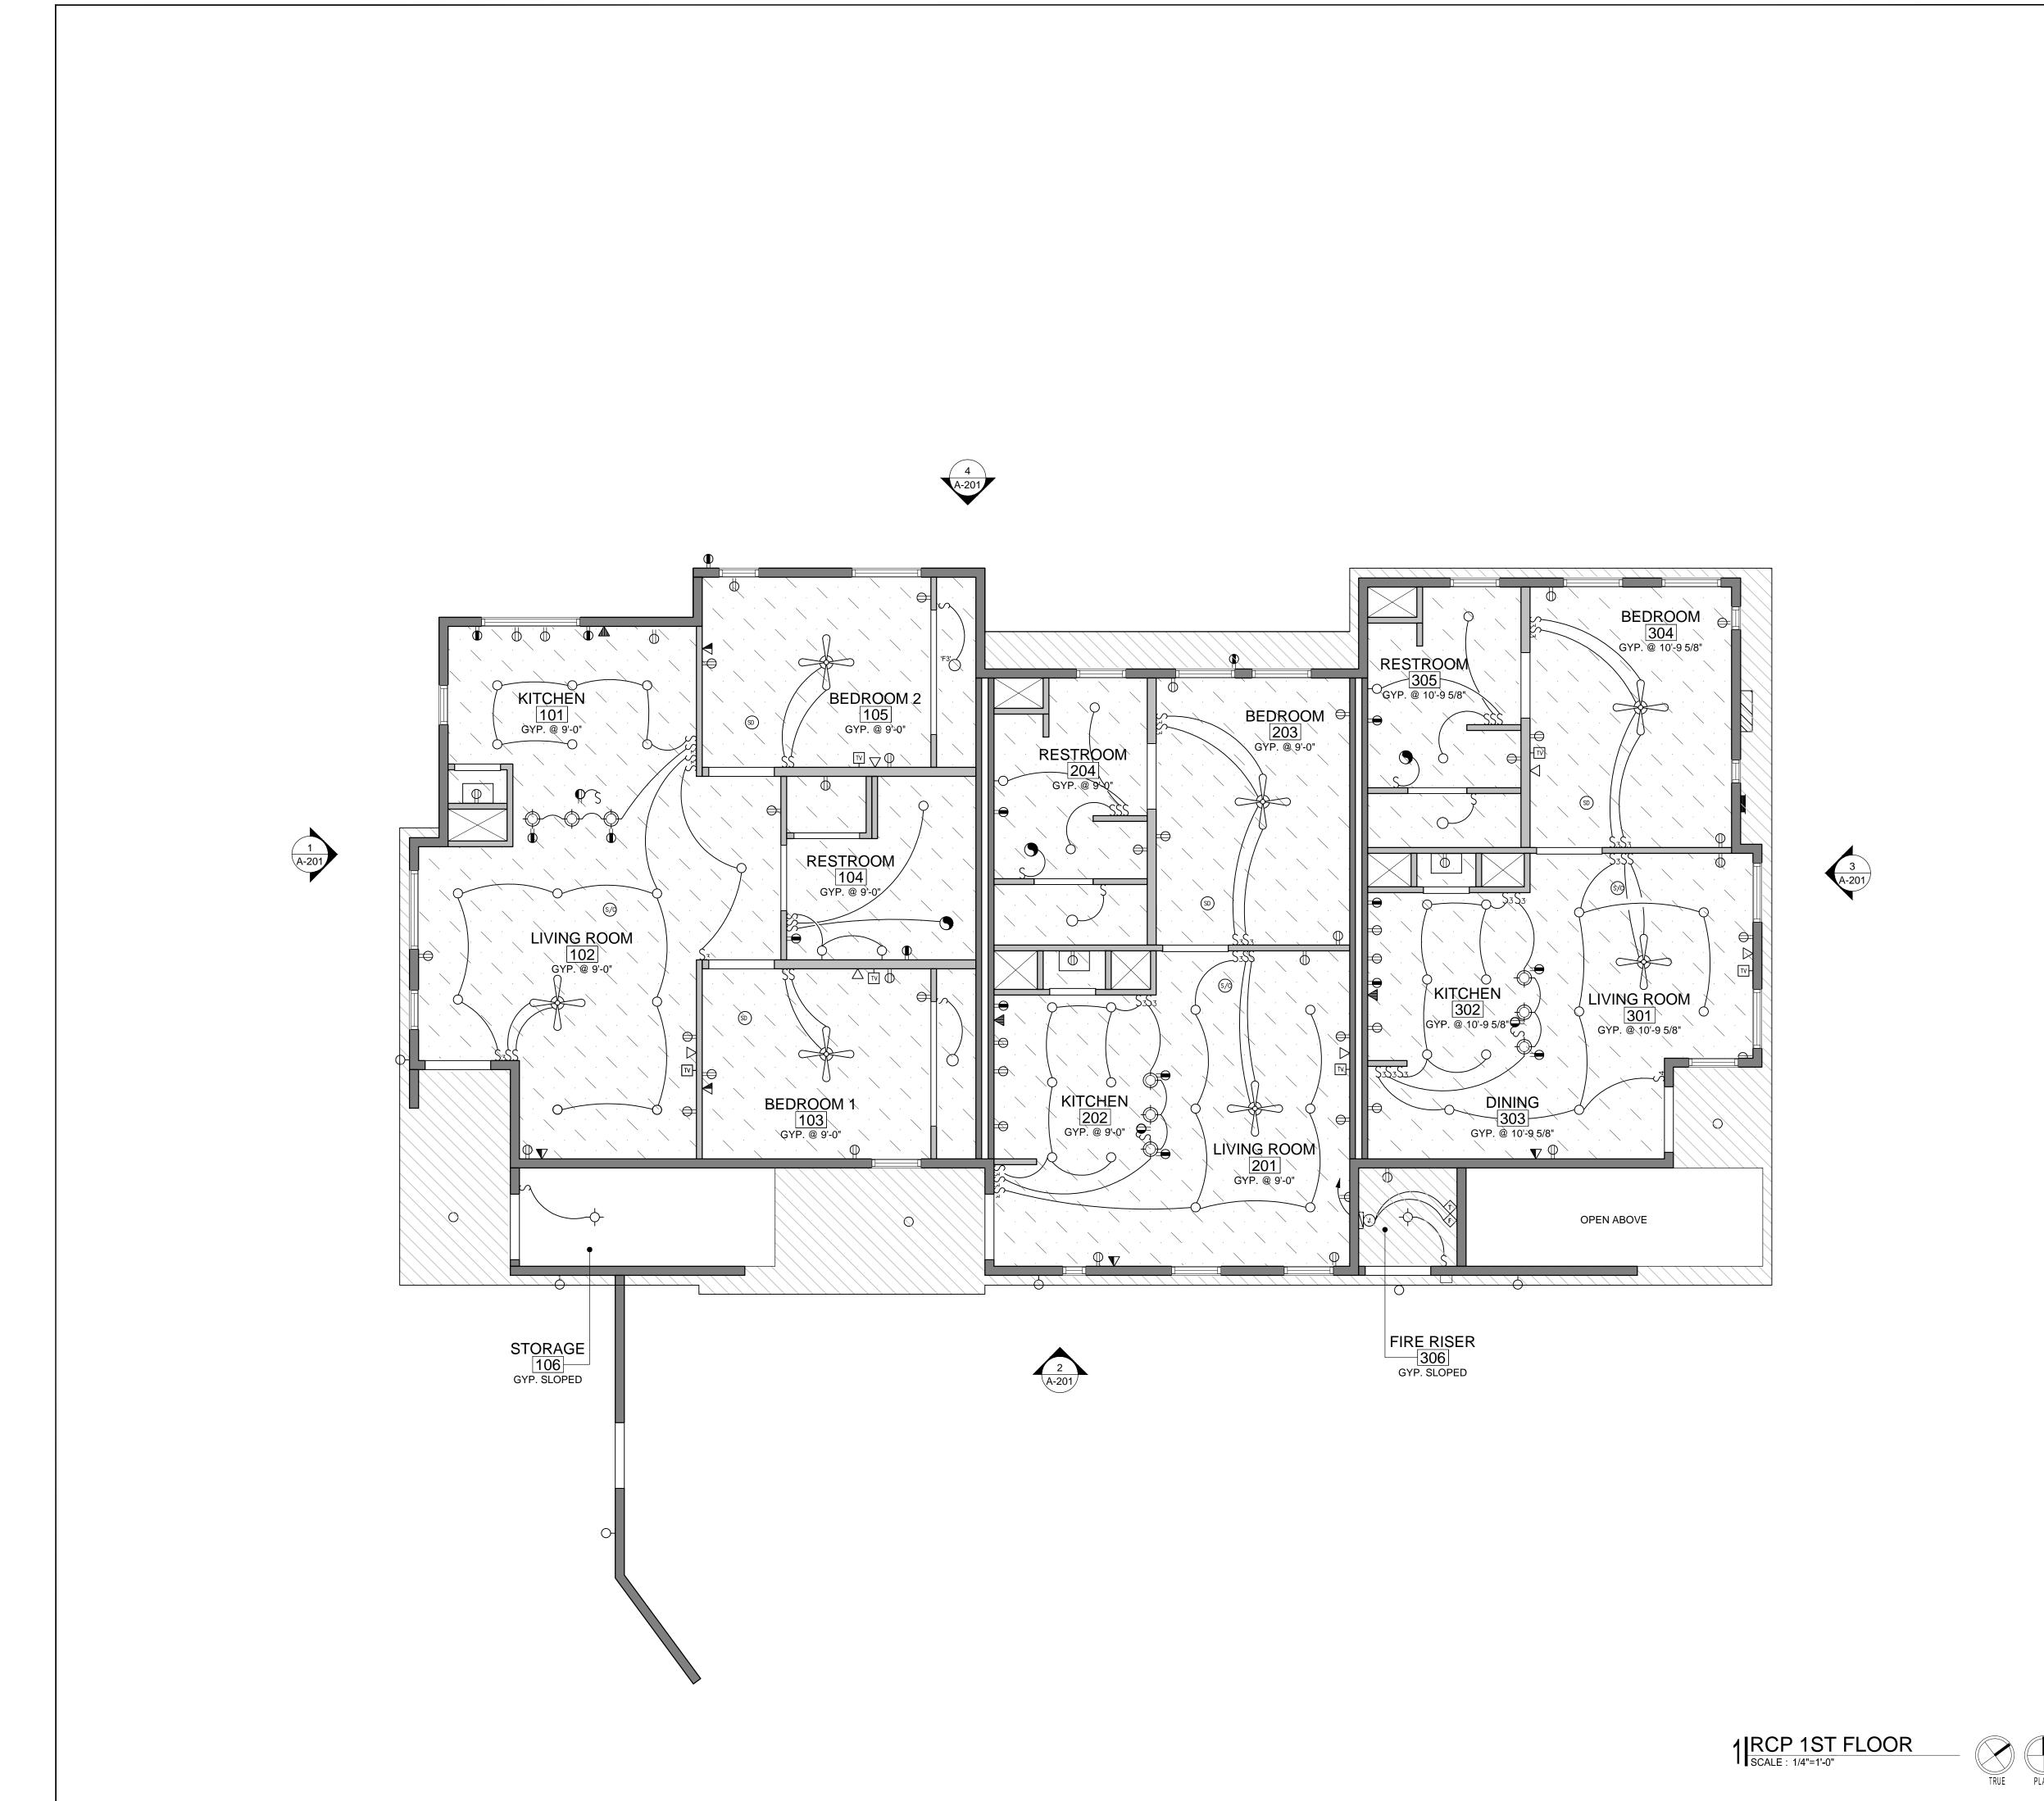

CEILING LEGEND:

STRUCTURAL BEAM

GYPSUM BOARD
OVERHANG ABOVE


DECK UNDERSIDE

REFLECTED CEILING PLAN GENERAL NOTES:

- 1. THE CONTRACTOR SHALL CAREFULLY STUDY AND COMPARE THE REFLECTED CEILING PLANS WITH: ELECTRICAL LIGHTING SYSTEMS AND COMMUNICATIONS DRAWINGS / AUDIO VISUAL DRAWINGS MECHANICAL SUPPLIES AND RETURNS EXHAUST DRAWINGS FIRE PROTECTION DRAWINGS CONTRACTOR TO IMMEDIATELY NOTIFY THE ARCHITECT OF ANY ERROR, INCONSISTENCY OR OMISSION.
- 2. SEE ELECTRICAL, COMMUNICATION, SECURITY AND FIRE PROTECTION DRAWINGS FOR LOCATIONS OF CEILING OR WALL MOUNTED SMOKE DETECTORS, COMMUNICATIONS DEVICES, SECURITY ALARMS, FIRE ALARM DEVICES, ETC. SOME OF THESE ITEMS ARE SHOWN ON THE ARCHITECTURAL PLANS AS WELL.
- 3. ALL FIXTURES ARE SHOWN FOR DIMENSIONAL LOCATION ONLY. VERIFY WITH ELECTRICAL DRAWINGS. ANY DISCREPANCIES SHALL BE BROUGHT TO THE ATTENTION OF THE ARCHITECT.
- 4. A COORDINATED PLAN OF ALL EXPOSED CEILING ELEMENTS SHALL BE SUBMITTED TO THE ARCHITECT FOR APPROVAL PRIOR TO DESIGN, PERMITTING, FABRICATION AND INSTALLATION OF ANY SYSTEMS OR A COORDINATION MEETING SHALL BE HELD CONFIRMING LOCATION OF ALL EXPOSED FIXTURES PRIOR TO INSTALLATION.
- 5. SPRINKLER HEADS (WHERE APPLICABLE):
 - a. SPRINKLER HEAD LOCATIONS ARE NOT INDICATED ON THE ARCHITECTURAL REFLECTED CEILING PLANS.
- b. THE CONTRACTOR SHALL INSTALL SUFFICIENT HEADS IN ALL SPACES TO PROVIDE COMPLETE (100%) AUTOMATIC SPRINKLER COVERAGE AS DEFINED BY NFPA STANDARD 13, SPECIFICATION DIVISION 21 FIRE SUPPRESSION AND AS SHOWN ON THE FIRE PROTECTION DRAWINGS (IF THEY ARE PROVIDED IN THIS DRAWING PACKAGE).
- c. NEITHER SPRINKLER HEADS NOR CONCEALED SPRINKLER HEAD COVERS ARE ALLOWED TO BE PAINTED. THE CONTRACTOR SHALL VERIFY THAT ANY SPRINKLER HEADS WHICH ARE ACCIDENTALLY PAINTED ARE REMOVED FROM THE SITE AND REPLACED WITH NEW SPRINKLER HEADS.
- 6. MEP ENGINEERS AND ARCHITECT TO REVIEW AND APPROVE LOCATIONS OF ALL LIGHTING CONTRACTOR-PROVIDED AND OWNER-PROVIDED, PRIOR TO INSTALLATION.
- 7. REFER TO FINISH SCHEDULE FOR GYPSUM BOARD PAINT COLORS AND OTHER MISC. PAINT COLORS.
- 8. ALL EXPOSED TO VIEW STRUCTURE, EQUIPMENT, CONDUIT AND APPLICABLE DEVICES ARE TO RECEIVE PAINT, COLOR AS SELECTED BY ARCHITECT.
- 9. ALL COUNDUIT IS TO BE CONCEALED FROM VIEW AS MUCH AS POSSIBLE. ROUTE CONDUITS IN FLUTES OF METAL DECK, IN SLAB OR TIGHT AGAINST METAL DECK AS APPROVED BY THE ARCHITECT.
- 10. FIRE SEAL ALL GAPS, CRACKS AND PENETRATIONS THROUGH CEILINGS AT RATED ASSEMBLIES ONLY.
- 11. VERIFY EXACT LOCATION FOR OWNER-PROVIDED, CEILING-MOUNTED EQUIPMENT AND DEVICES.
- 12. LOCATE AIR DEVICES, SPEAKERS, FIRE ALARM DEVICES AND SPRINKLER HEADS THOUGHTFULLY. ALIGN DEVICES AND CENTER IN THE CEILING PANEL WHERE POSSIBLE.
- 13. ANY ITEMS SUSPENDED FROM THE CEILING OR INSTALLED ON AN INTERIOR WALL IN ANY COMMERCIAL PROJECT MUST NOT HANG LOWER THAN 84" ABOVE THE FINISHED FLOOR.

REFLECTED CEILING PLAN KEYNOTES

1 XXX 2 XXX

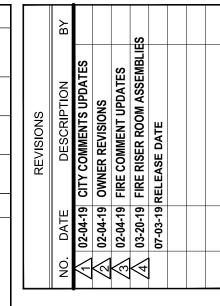



7010 Easy Wind Dr. Ste 200 Austin, TX 78752 512.899.3100

www.designopa.com

ZOISI LEXAS HENDERSON, NEVADA 89015

2018 OPA Design Studio. All Rights Reserved.
These designs / drawings are the sole property of
the Architect, OPA Design Studio. They may not
be reproduced in any form, by any method, for
any purpose without previous written permission
from the Architect.

PRICING

SET

JOB NO.: 201724-C


PHASE: CD


DRAWN: SO, LE, NC


CHECKED: SO

DATE: 03/20/2019

A104
1ST FLOOR RCP

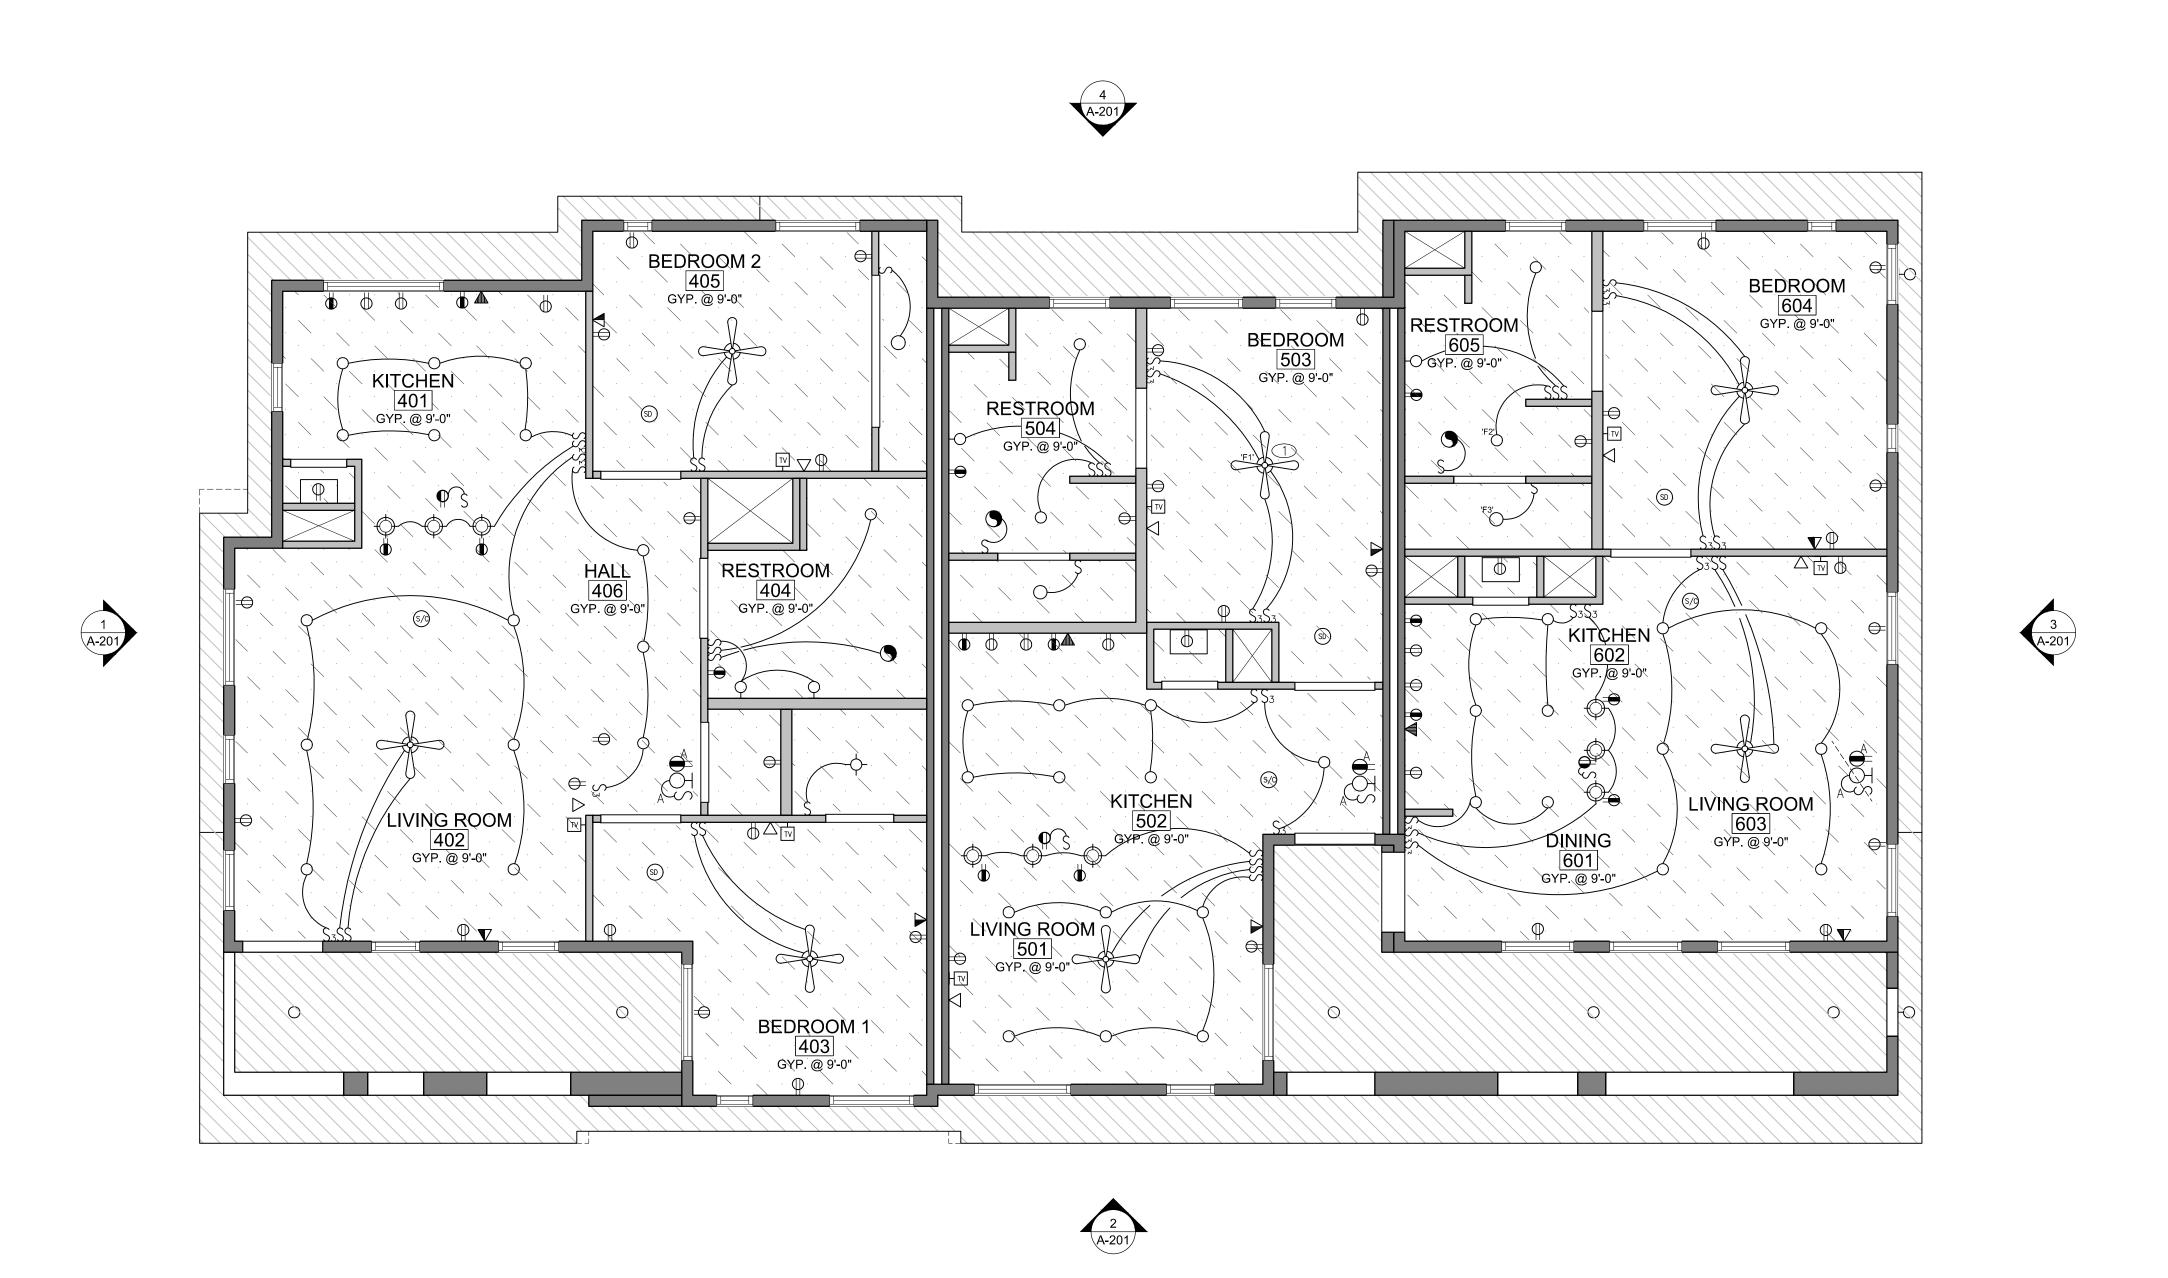

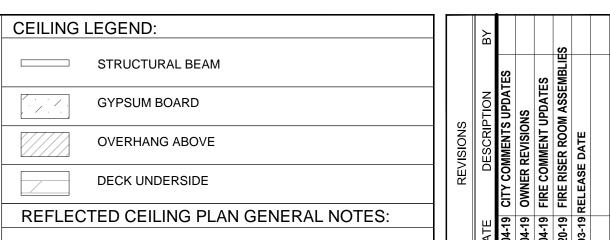

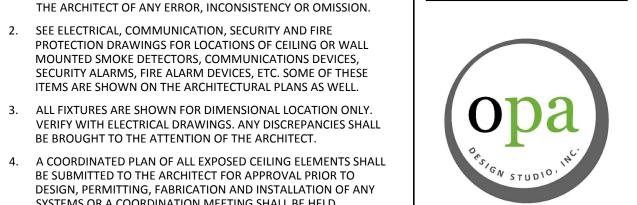

7010 Easy Wind Dr. Ste 200 Austin, TX 78752

512.899.3100 www.designopa.com

REPLACED WITH NEW SPRINKLER HEADS. 6. MEP ENGINEERS AND ARCHITECT TO REVIEW AND APPROVE LOCATIONS OF ALL LIGHTING - CONTRACTOR-PROVIDED AND OWNER-PROVIDED, PRIOR TO INSTALLATION.

1. THE CONTRACTOR SHALL CAREFULLY STUDY AND COMPARE THE REFLECTED CEILING PLANS WITH: ELECTRICAL LIGHTING SYSTEMS AND COMMUNICATIONS DRAWINGS / AUDIO VISUAL DRAWINGS MECHANICAL SUPPLIES AND RETURNS EXHAUST DRAWINGS FIRE PROTECTION DRAWINGS CONTRACTOR TO IMMEDIATELY NOTIFY THE ARCHITECT OF ANY ERROR, INCONSISTENCY OR OMISSION.

PROTECTION DRAWINGS FOR LOCATIONS OF CEILING OR WALL MOUNTED SMOKE DETECTORS, COMMUNICATIONS DEVICES, SECURITY ALARMS, FIRE ALARM DEVICES, ETC. SOME OF THESE ITEMS ARE SHOWN ON THE ARCHITECTURAL PLANS AS WELL. 3. ALL FIXTURES ARE SHOWN FOR DIMENSIONAL LOCATION ONLY. VERIFY WITH ELECTRICAL DRAWINGS. ANY DISCREPANCIES SHALL

2. SEE ELECTRICAL, COMMUNICATION, SECURITY AND FIRE

BE BROUGHT TO THE ATTENTION OF THE ARCHITECT.

ARCHITECTURAL REFLECTED CEILING PLANS.

PROVIDED IN THIS DRAWING PACKAGE).

INSTALLATION.

5. SPRINKLER HEADS (WHERE APPLICABLE):

BE SUBMITTED TO THE ARCHITECT FOR APPROVAL PRIOR TO DESIGN, PERMITTING, FABRICATION AND INSTALLATION OF ANY SYSTEMS OR A COORDINATION MEETING SHALL BE HELD CONFIRMING LOCATION OF ALL EXPOSED FIXTURES PRIOR TO

a. SPRINKLER HEAD LOCATIONS ARE NOT INDICATED ON THE

b. THE CONTRACTOR SHALL INSTALL SUFFICIENT HEADS IN ALL SPACES TO PROVIDE COMPLETE (100%) AUTOMATIC SPRINKLER COVERAGE AS DEFINED BY NFPA STANDARD 13,

SPECIFICATION DIVISION 21 - FIRE SUPPRESSION AND AS SHOWN ON THE FIRE PROTECTION DRAWINGS (IF THEY ARE

c. NEITHER SPRINKLER HEADS NOR CONCEALED SPRINKLER HEAD COVERS ARE ALLOWED TO BE PAINTED. THE CONTRACTOR SHALL VERIFY THAT ANY SPRINKLER HEADS WHICH ARE

ACCIDENTALLY PAINTED ARE REMOVED FROM THE SITE AND

7. REFER TO FINISH SCHEDULE FOR GYPSUM BOARD PAINT COLORS AND OTHER MISC. PAINT COLORS.

8. ALL EXPOSED TO VIEW STRUCTURE, EQUIPMENT, CONDUIT AND APPLICABLE DEVICES ARE TO RECEIVE PAINT, COLOR AS SELECTED BY ARCHITECT.

9. ALL COUNDUIT IS TO BE CONCEALED FROM VIEW AS MUCH AS POSSIBLE. ROUTE CONDUITS IN FLUTES OF METAL DECK, IN SLAB OR TIGHT AGAINST METAL DECK AS APPROVED BY THE ARCHITECT.

10. FIRE SEAL ALL GAPS, CRACKS AND PENETRATIONS THROUGH CEILINGS AT RATED ASSEMBLIES ONLY.

11. VERIFY EXACT LOCATION FOR OWNER-PROVIDED, CEILING-MOUNTED EQUIPMENT AND DEVICES.

12. LOCATE AIR DEVICES, SPEAKERS, FIRE ALARM DEVICES AND SPRINKLER HEADS THOUGHTFULLY. ALIGN DEVICES AND CENTER IN THE CEILING PANEL WHERE POSSIBLE.

13. ANY ITEMS SUSPENDED FROM THE CEILING OR INSTALLED ON AN INTERIOR WALL IN ANY COMMERCIAL PROJECT MUST NOT HANG LOWER THAN 84" ABOVE THE FINISHED FLOOR.

REFLECTED CEILING PLAN KEYNOTES

1 XXX 2 XXX

890

PRICING SET

2018 OPA Design Studio. All Rights Reserved. These designs / drawings are the sole property of the Architect, OPA Design Studio. They may not be reproduced in any form, by any method, for any purpose without previous written permission from the Architect.

JOB NO.:	201724-C
PHASE:	CD
DRAWN:	SO, LE, NC
CHECKED	: SO
DATE:	03/20/2019

2ND FLOOR RCP

SHEET NOTES

- DIMENSIONS ARE TO FACE OF STUD UNLESS NOTED OTHERWISE.
- 2. THIS DESIGN ASSUMES 6" WOOD STUDS AT BUILDING PERIMETER WITH R19 BATT INSULATION. "LINE OF STRUCTURE" REFERS TO OUTSIDE EDGE OF STRUCTURE/INSIDE FACE OF PERIMETER STUDS

KEYNOTES

1 EXTERIOR ELEVATION SCALE: 3/16" = 1'-0"

- 1) SHINGLE ROOF
- 2 STUCCO SIDING W/ CONTROL JOINTS
- 3 HORIZANTAL WOOD SIDING ACCENT
 4 VERTICAL ACCENT SIDING
- 5 OPENING IN EXTERIOR SURFACE W/ STEEL TRIM
 6 A.C. UNIT PER MEP
- 7) 6'-0" HIGH TRECK FENCING TRASH ENCLOSURE
- 8 STEEL RAILING
- 9 RETAINING WALL PER CIVIL SITE PLAN
- 10) ADA RAMP PER CIVIL SITE PLAN
- 11) DOWNSPOUT
- (12) UTILITY BOX PER MEP
- 13 6'-0" HIGH TRECK FENCING UTILITY SCREEN.
- (14) 6'-0" HIGH TREK FENCE ALONG PROPERTY LINE. (15) 8'-6" HIGH STUCCO WING WALL AND GATE OVER
- FRONT ENTRY PATH PER CITY OF HENDERSON BUILDING FRONTAGE REQUIREMENTS.
- (16) ILLUMINATED 14" HIGH BUILDING ADDRESS NUMBERS VISIBLE FROM THE STREET/ALLEY AND CONFORMING WITH THE REQUIREMENTS OF COH DEV CODE SECTION 19.9.15.

NO. DATE DESCRIPTION

102-04-19 CITY COMMENTS UPDATES

202-04-19 OWNER REVISIONS

302-04-19 FIRE COMMENT UPDATES

403-20-19 FIRE RISER ROOM ASSEMBLIES

07-03-19 RELEASE DATE



7010 Easy Wind Dr. Ste 200 Austin, TX 78752 512.899.3100

www.designopa.com

251 S. TEXAS
HENDERSON, NEVADA 89015

2018 OPA Design Studio. All Rights Reserved. These designs / drawings are the sole property of the Architect, OPA Design Studio. They may not be reproduced in any form, by any method, for any purpose without previous written permission from the Architect.

PRICING

SET

from the Architect.

JOB NO.: 201724-C

PHASE: CD

DRAWN: SO, LE, NC

CHECKED: SO

DATE: 03/20/2019

A201
EXTERIOR ELEVATIONS

SHEET NOTES

- DIMENSIONS ARE TO FACE OF STUD UNLESS NOTED OTHERWISE.
- 2. THIS DESIGN ASSUMES 6" WOOD STUDS AT BUILDING PERIMETER WITH R19 BATT INSULATION. "LINE OF STRUCTURE" REFERS TO OUTSIDE EDGE OF STRUCTURE/INSIDE FACE OF PERIMETER STUDS

KEYNOTES

1 EXTERIOR ELEVATION SCALE: 3/16" = 1'-0"

- 1) SHINGLE ROOF
- 2 STUCCO SIDING W/ CONTROL JOINTS
- 3 HORIZANTAL WOOD SIDING ACCENT
 4 VERTICAL ACCENT SIDING
- (4) VERTICAL ACCENT SIDING
 (5) OPENING IN EXTERIOR SURFACE W/ STEEL TRIM
- 6 A.C. UNIT PER MEP
- 7 6'-0" HIGH TRECK FENCING TRASH ENCLOSURE

 (8) STEEL RAILING
- (9) RETAINING WALL PER CIVIL SITE PLAN
- (10) ADA RAMP PER CIVIL SITE PLAN
- (10) ADA RAMP PER CIVIL SITE (11) DOWNSPOUT
- (12) UTILITY BOX PER MEP
- 13 6'-0" HIGH TRECK FENCING UTILITY SCREEN.
- 14) 6'-0" HIGH TREK FENCE ALONG PROPERTY LINE. 15) 8'-6" HIGH STUCCO WING WALL AND GATE OVER
- FRONT ENTRY PATH PER CITY OF HENDERSON BUILDING FRONTAGE REQUIREMENTS.
- (16) ILLUMINATED 14" HIGH BUILDING ADDRESS NUMBERS VISIBLE FROM THE STREET/ALLEY AND CONFORMING WITH THE REQUIREMENTS OF COH DEV CODE SECTION 19.9.15.

NO. DATE DESCRIPTION

102-04-19 CITY COMMENTS UPDATES

102-04-19 FIRE COMMENT UPDATES

103-20-19 FIRE RISER ROOM ASSEMBLIE

107-03-19 RELEASE DATE



7010 Easy Wind Dr. Ste 200 Austin, TX 78752 512.899.3100

www.designopa.com

LOIO. IENAD HENDERSON, NEVADA 89015

2018 OPA Design Studio. All Rights Reserved. These designs / drawings are the sole property of the Architect, OPA Design Studio. They may not be reproduced in any form, by any method, for any purpose without previous written permission from the Architect.

PRICING

SET

from the Architect.

JOB NO.: 201724-C

PHASE: CD


DRAWN: SO, LE, NC


CHECKED: SO

DATE: 03/20/2019

A202

EXTERIOR ELEVATIONS

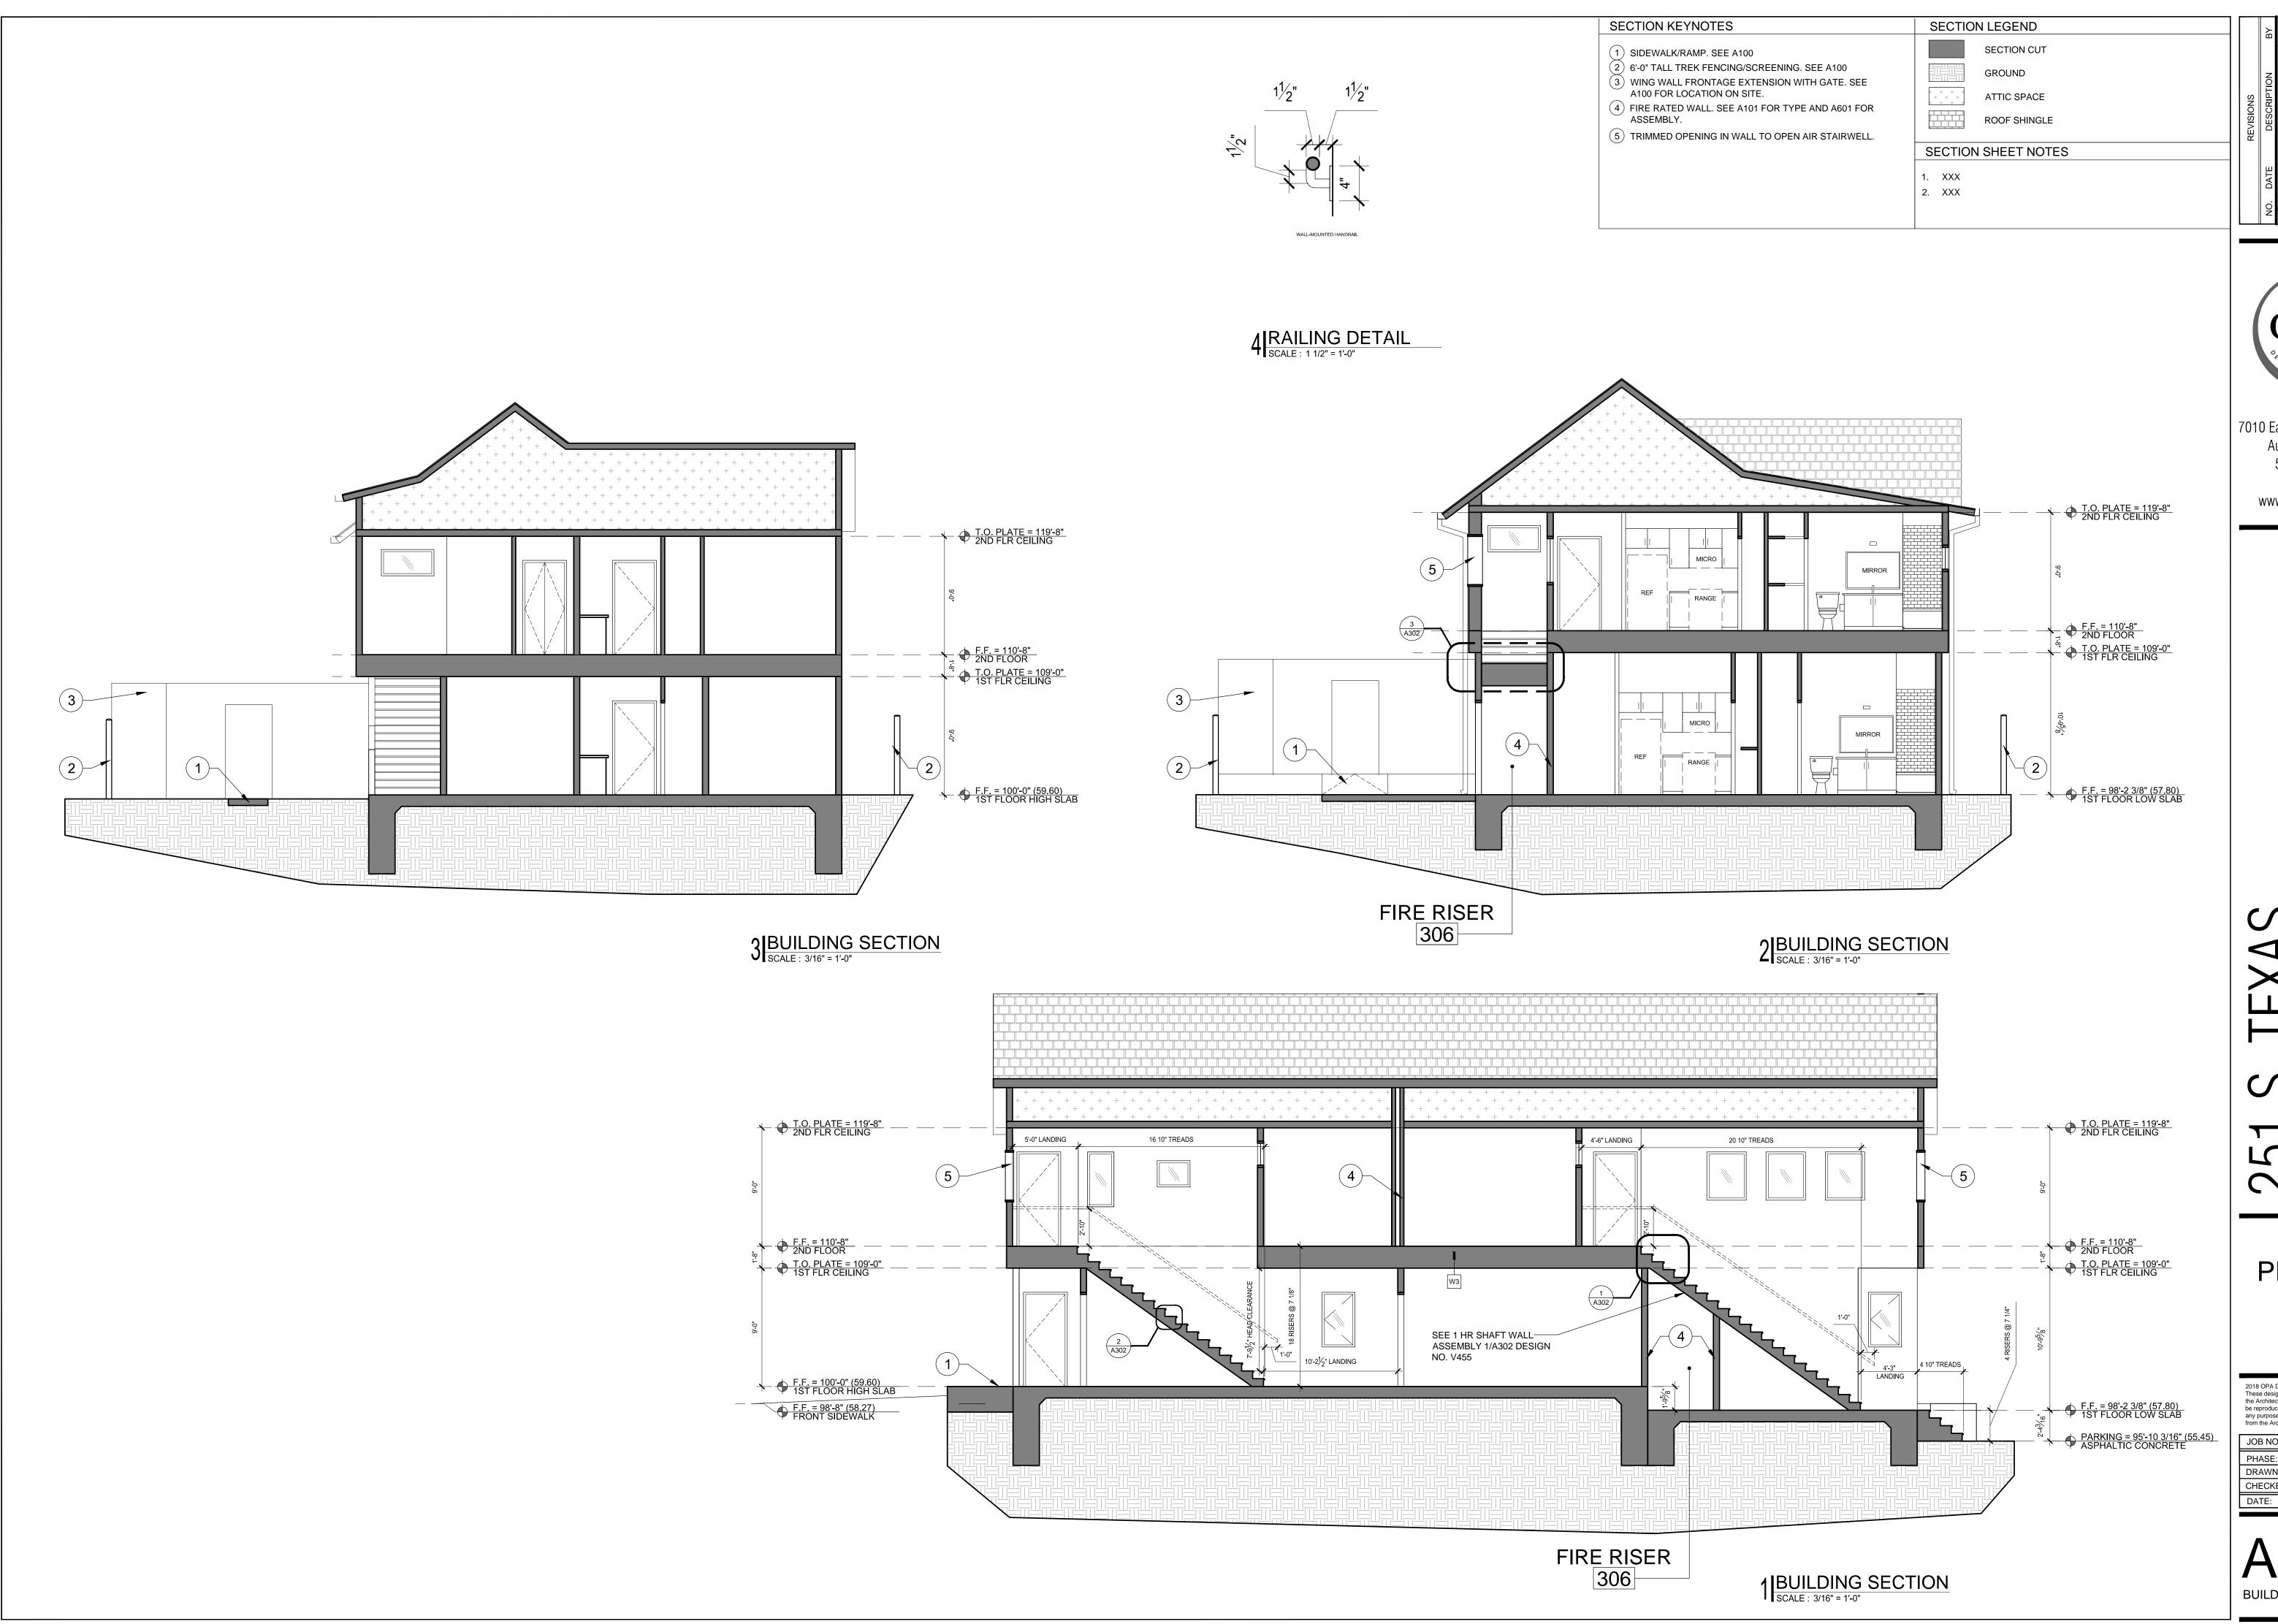

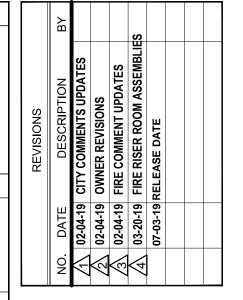



7010 Easy Wind Dr. Ste 200 Austin, TX 78752 512.899.3100

www.designopa.com


890

PRICING SET


2018 OPA Design Studio. All Rights Reserved.
These designs / drawings are the sole property of
the Architect, OPA Design Studio. They may not
be reproduced in any form, by any method, for
any purpose without previous written permission

om the Archite	ect.	
IOB NO.:	201724-C	
PHASE:	CD	
RAWN:	SO, LE, NC	
HECKED	: SO	
) \ T E :	03/20/2010	


BUILDING SECTIONS

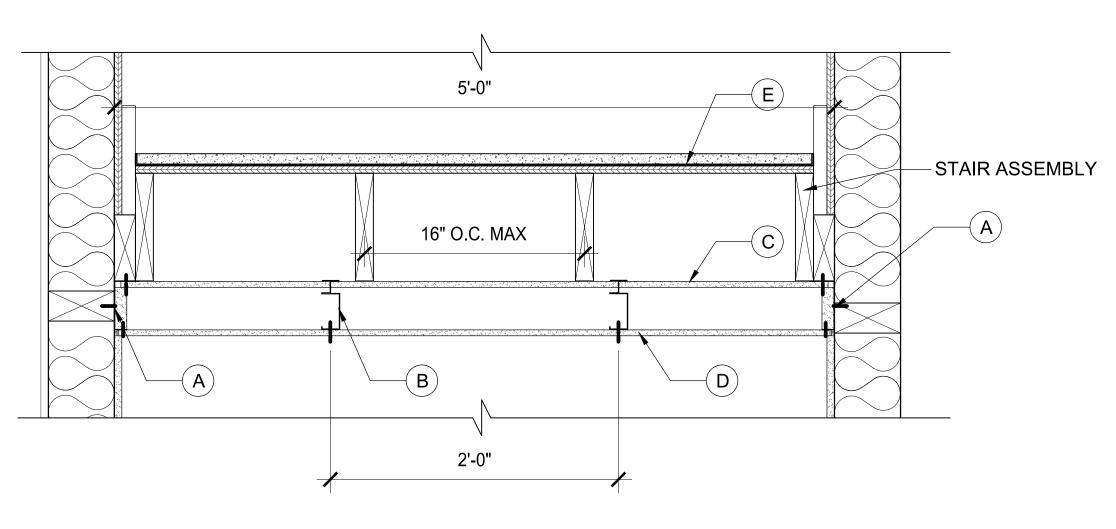

3 BACK STAIR SECTION 1 HR FIRE ASSEMBLY DESIGN NO: V455

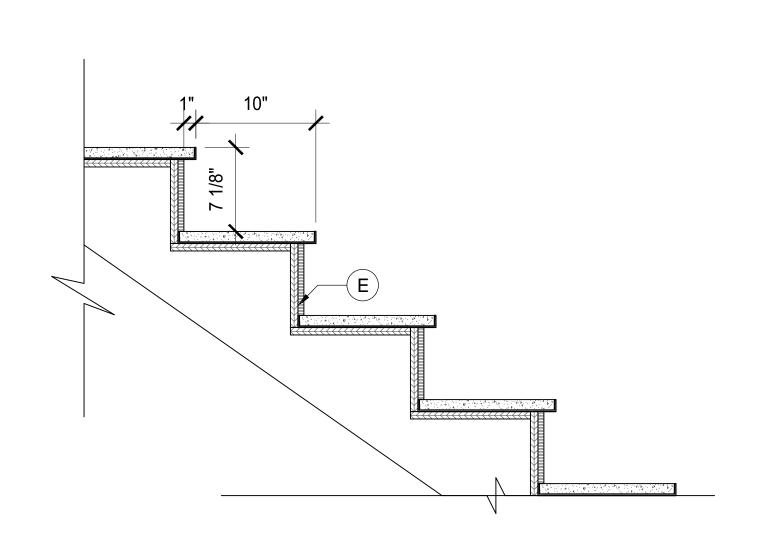

2 FRONT STAIR DETAIL SCALE: 1 1/2" = 1'-0"

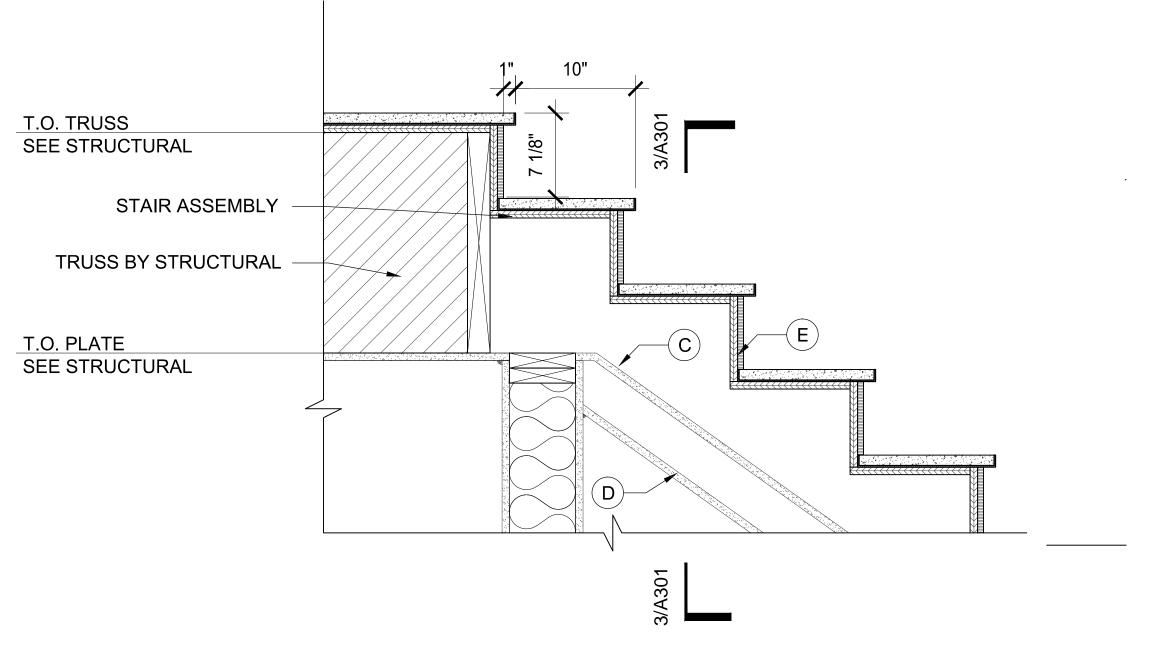

1 BACK STAIR DETAIL 1 HR FIRE ASSEMBLY DESIGN NO: V455 SCALE: 1-1/2" = 1'-0"

1 HR FIRE ASSEMBLY DESIGN No: V455

A. FLOOR, SIDE, AND CEILING RUNNERS - "J"-SHAPED RUNNER, MIN 2-1/2 IN. DEEP WITH UNEQUAL LEGS OF 1 IN. AND 2 IN. FABRICATED FROM MIN 25 MSG GALV. STEEL. RUNNERS POSITIONED WITH SHORT LEG TOWARD FINISHED SIDE OF WALL. RUNNERS ATTACHED TO STRUCTURAL SUPPORTS WITH STEEL FASTENERS LOCATED NOT GREATER THAN 2 IN. FROM ENDS AND NOT GREATER THAN 24 IN. OC.

B. FURRING CHANNELS - RESILIENT FURRING CHANNELS FABRICATED FROM MIN 25 MSG CORROSION PROTECTED STEEL, INSTALLED HORIZONTALLY, AND SPACED VERTICALLY A MAX 24 IN. OC. FLANGE PORTION OF CHANNEL ATTACHED TO EACH

INTERSECTING "C-H" OR "E" STUD ON SIDE OF STUD OPPOSITE THE 1 IN. LINER PANELS WITH $\frac{1}{2}$ IN. LONG TYPE S OR S-12 PAN-HEAD STEEL SCREWS.

C. GYPSUM BOARD - GYPSUM LINER PANEL, NOM. 1 IN. THICK 24 IN. WIDE. PANELS CUT MAX 1 IN. LESS IN LENGTH THAN FLOOR TO CEILING HEIGHT. VERTICAL EDGES INSERTED IN "T" SHAPED SECTION OF "C-T" STUDS. VERTICAL EDGES INSERTED IN "H" SHAPED SECTION OF "C-H" STUDS, OR HOLDING TABS OF "I" STUDS. FREE EDGE OF END PANELS ATTACHED TO LONG LEG OF "J" -RUNNERS WITH 1-5/8 IN. LONG TYPE "S" BUGLE HEAD STEEL SCREWS SPACES NOT GREATER THAN 12 IN. O.C.


AMERICAN GYPSUM CO - TYPE AG-S, M-GLASS

D. GYPSUM BOARD - GYPSUM PANELS, NOM ⁵/₈ IN, THICK, 48 IN. WIDE, APPLIED VERTICALLY WITH EDGES CENTERED OVER STUDS, WITH 1

SCREWS SPACED 12 IN OC.

IN. LONG TYPE S BUGLE HEAD STEEL

E. WATERPROOF MEMBRANE (CONTINUOUS OVER ENCLOSED)

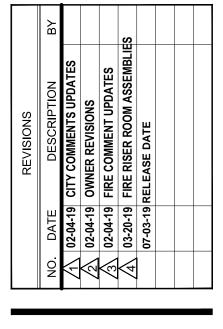



7010 Easy Wind Dr. Ste 200 Austin, TX 78752 512.899.3100

www.designopa.com

| Z51 S. | EXAS | HENDERSON, NEVADA 89015

2018 OPA Design Studio. All Rights Reserved.
These designs / drawings are the sole property of
the Architect, OPA Design Studio. They may not
be reproduced in any form, by any method, for
any purpose without previous written permission
from the Architect.

PRICING

SET

JOB NO.:	201724-C	
PHASE:	CD	
DRAWN:	SO, LE, NC	
CHECKED:	SO	
DATE:	03/20/2019	

A302
STAIR DETAILS



ACCESSIBILITY TOLERANCES:

- 1. TOILET HEIGHT 17" 19"
- 2. LOCATE TOILET PAPER DISPENSER BETWEEEN 15" 48" A.F.F. AND BETWEEN 7"-9" IN FRONT OF TOILET.
- 3. ALLOW MIN. 1 1/2" MIN. CLEARANCE BETWEEN GRAB BAR
- AND OTHER TOILET ACCESSORIES.
- 4. LOCATE OTHER TOILET ACCESSORIES SUCH THAT
- OPERABLE PORTIONS ARE BETWEEN 15" AND 48" A.F.F.

SHEET NOTES

- FOOD SERVICE EQUIPMENT TO BE PROVIDED AND INSTALLED BY OWNER U.N.O.
- 2. COORDINATE WITH OWNER FOR EXACT LOCATIONS OF WATER CONNECTIONS REQUIRED BY EQUIPMENT AND
- 3. PROVIDE FLOOR SINK AT ICE MACHINE AS REQUIRED -
- 4. PROVIDE WATER RESISTANT GYP. BOARD WITHIN 4' OF PLUMBING FIXTURE U.N.O.
- 5. SEE REFLECTED CEILING PLAN FOR POWER, DATA AND LIGHTING LOCATIONS.



7010 Easy Wind Dr. Ste 200 Austin, TX 78752 512.899.3100

www.designopa.com

890

PRICING SET

	2018 OPA Design Studio. All Rights Reserved These designs / drawings are the sole property the Architect, OPA Design Studio. They may re be reproduced in any form, by any method, for any purpose without previous written permissic
_	from the Architect.

	JOB NO.:	201724-C
	PHASE:	CD
	DRAWN:	SO, LE, NC
	CHECKED:	SO
	DATE:	03/20/2019

INTERIOR ELEVATIONS



ACCESSIBILITY TOLERANCES:

- 1. TOILET HEIGHT 17" 19"
- 2. LOCATE TOILET PAPER DISPENSER BETWEEEN 15" 48" A.F.F. AND BETWEEN 7"-9" IN FRONT OF TOILET.
- 3. ALLOW MIN. 1 1/2" MIN. CLEARANCE BETWEEN GRAB BAR
- AND OTHER TOILET ACCESSORIES.
- 4. LOCATE OTHER TOILET ACCESSORIES SUCH THAT OPERABLE PORTIONS ARE BETWEEN 15" AND 48" A.F.F.
- 5. WRAP EXPOSED WASTE PIPE AT LAVATORIES.

SHEET NOTES

- 1. FOOD SERVICE EQUIPMENT TO BE PROVIDED AND INSTALLED BY OWNER U.N.O.
- 2. COORDINATE WITH OWNER FOR EXACT LOCATIONS OF WATER CONNECTIONS REQUIRED BY EQUIPMENT AND APPLIANCES.
- 3. PROVIDE FLOOR SINK AT ICE MACHINE AS REQUIRED -VERIFY WITH OWNER.
- 4. PROVIDE WATER RESISTANT GYP. BOARD WITHIN 4' OF PLUMBING FIXTURE U.N.O.
- 5. SEE REFLECTED CEILING PLAN FOR POWER, DATA AND LIGHTING LOCATIONS.



7010 Easy Wind Dr. Ste 200 Austin, TX 78752 512.899.3100

www.designopa.com

890

PRICING SET

2018 OPA Design Studio. All Rights Reserved.
These designs / drawings are the sole property of
the Architect, OPA Design Studio. They may not
be reproduced in any form, by any method, for
any purpose without previous written permission
from the Architect.

	JOB NO.:	201724-C
	PHASE:	CD
	DRAWN:	SO, LE, NC
	CHECKED:	SO
	DATE:	03/20/2019

INTERIOR ELEVATIONS



ACCESSIBILITY TOLERANCES:

- 1. TOILET HEIGHT 17" 19"
- 2. LOCATE TOILET PAPER DISPENSER BETWEEEN 15" 48" A.F.F. AND BETWEEN 7"-9" IN FRONT OF TOILET.
- 3. ALLOW MIN. 1 1/2" MIN. CLEARANCE BETWEEN GRAB BAR
- AND OTHER TOILET ACCESSORIES.
- 4. LOCATE OTHER TOILET ACCESSORIES SUCH THAT OPERABLE PORTIONS ARE BETWEEN 15" AND 48" A.F.F.
- 5. WRAP EXPOSED WASTE PIPE AT LAVATORIES.

SHEET NOTES

- 1. FOOD SERVICE EQUIPMENT TO BE PROVIDED AND INSTALLED BY OWNER U.N.O.
- 2. COORDINATE WITH OWNER FOR EXACT LOCATIONS OF WATER CONNECTIONS REQUIRED BY EQUIPMENT AND APPLIANCES.
- 3. PROVIDE FLOOR SINK AT ICE MACHINE AS REQUIRED -VERIFY WITH OWNER.
- 4. PROVIDE WATER RESISTANT GYP. BOARD WITHIN 4' OF PLUMBING FIXTURE U.N.O.
- 5. SEE REFLECTED CEILING PLAN FOR POWER, DATA AND LIGHTING LOCATIONS.



7010 Easy Wind Dr. Ste 200 Austin, TX 78752 512.899.3100

www.designopa.com

890


2018 OPA Design Studio. All Rights Reserved. These designs / drawings are the sole property of the Architect, OPA Design Studio. They may not be reproduced in any form, by any method, for any purpose without previous written permission from the Architect.

PRICING

SET

Ι.		
	JOB NO.:	201724-C
	PHASE:	CD
	DRAWN:	SO, LE, NC
	CHECKED:	SO
	DATE:	03/20/2019

INTERIOR ELEVATIONS

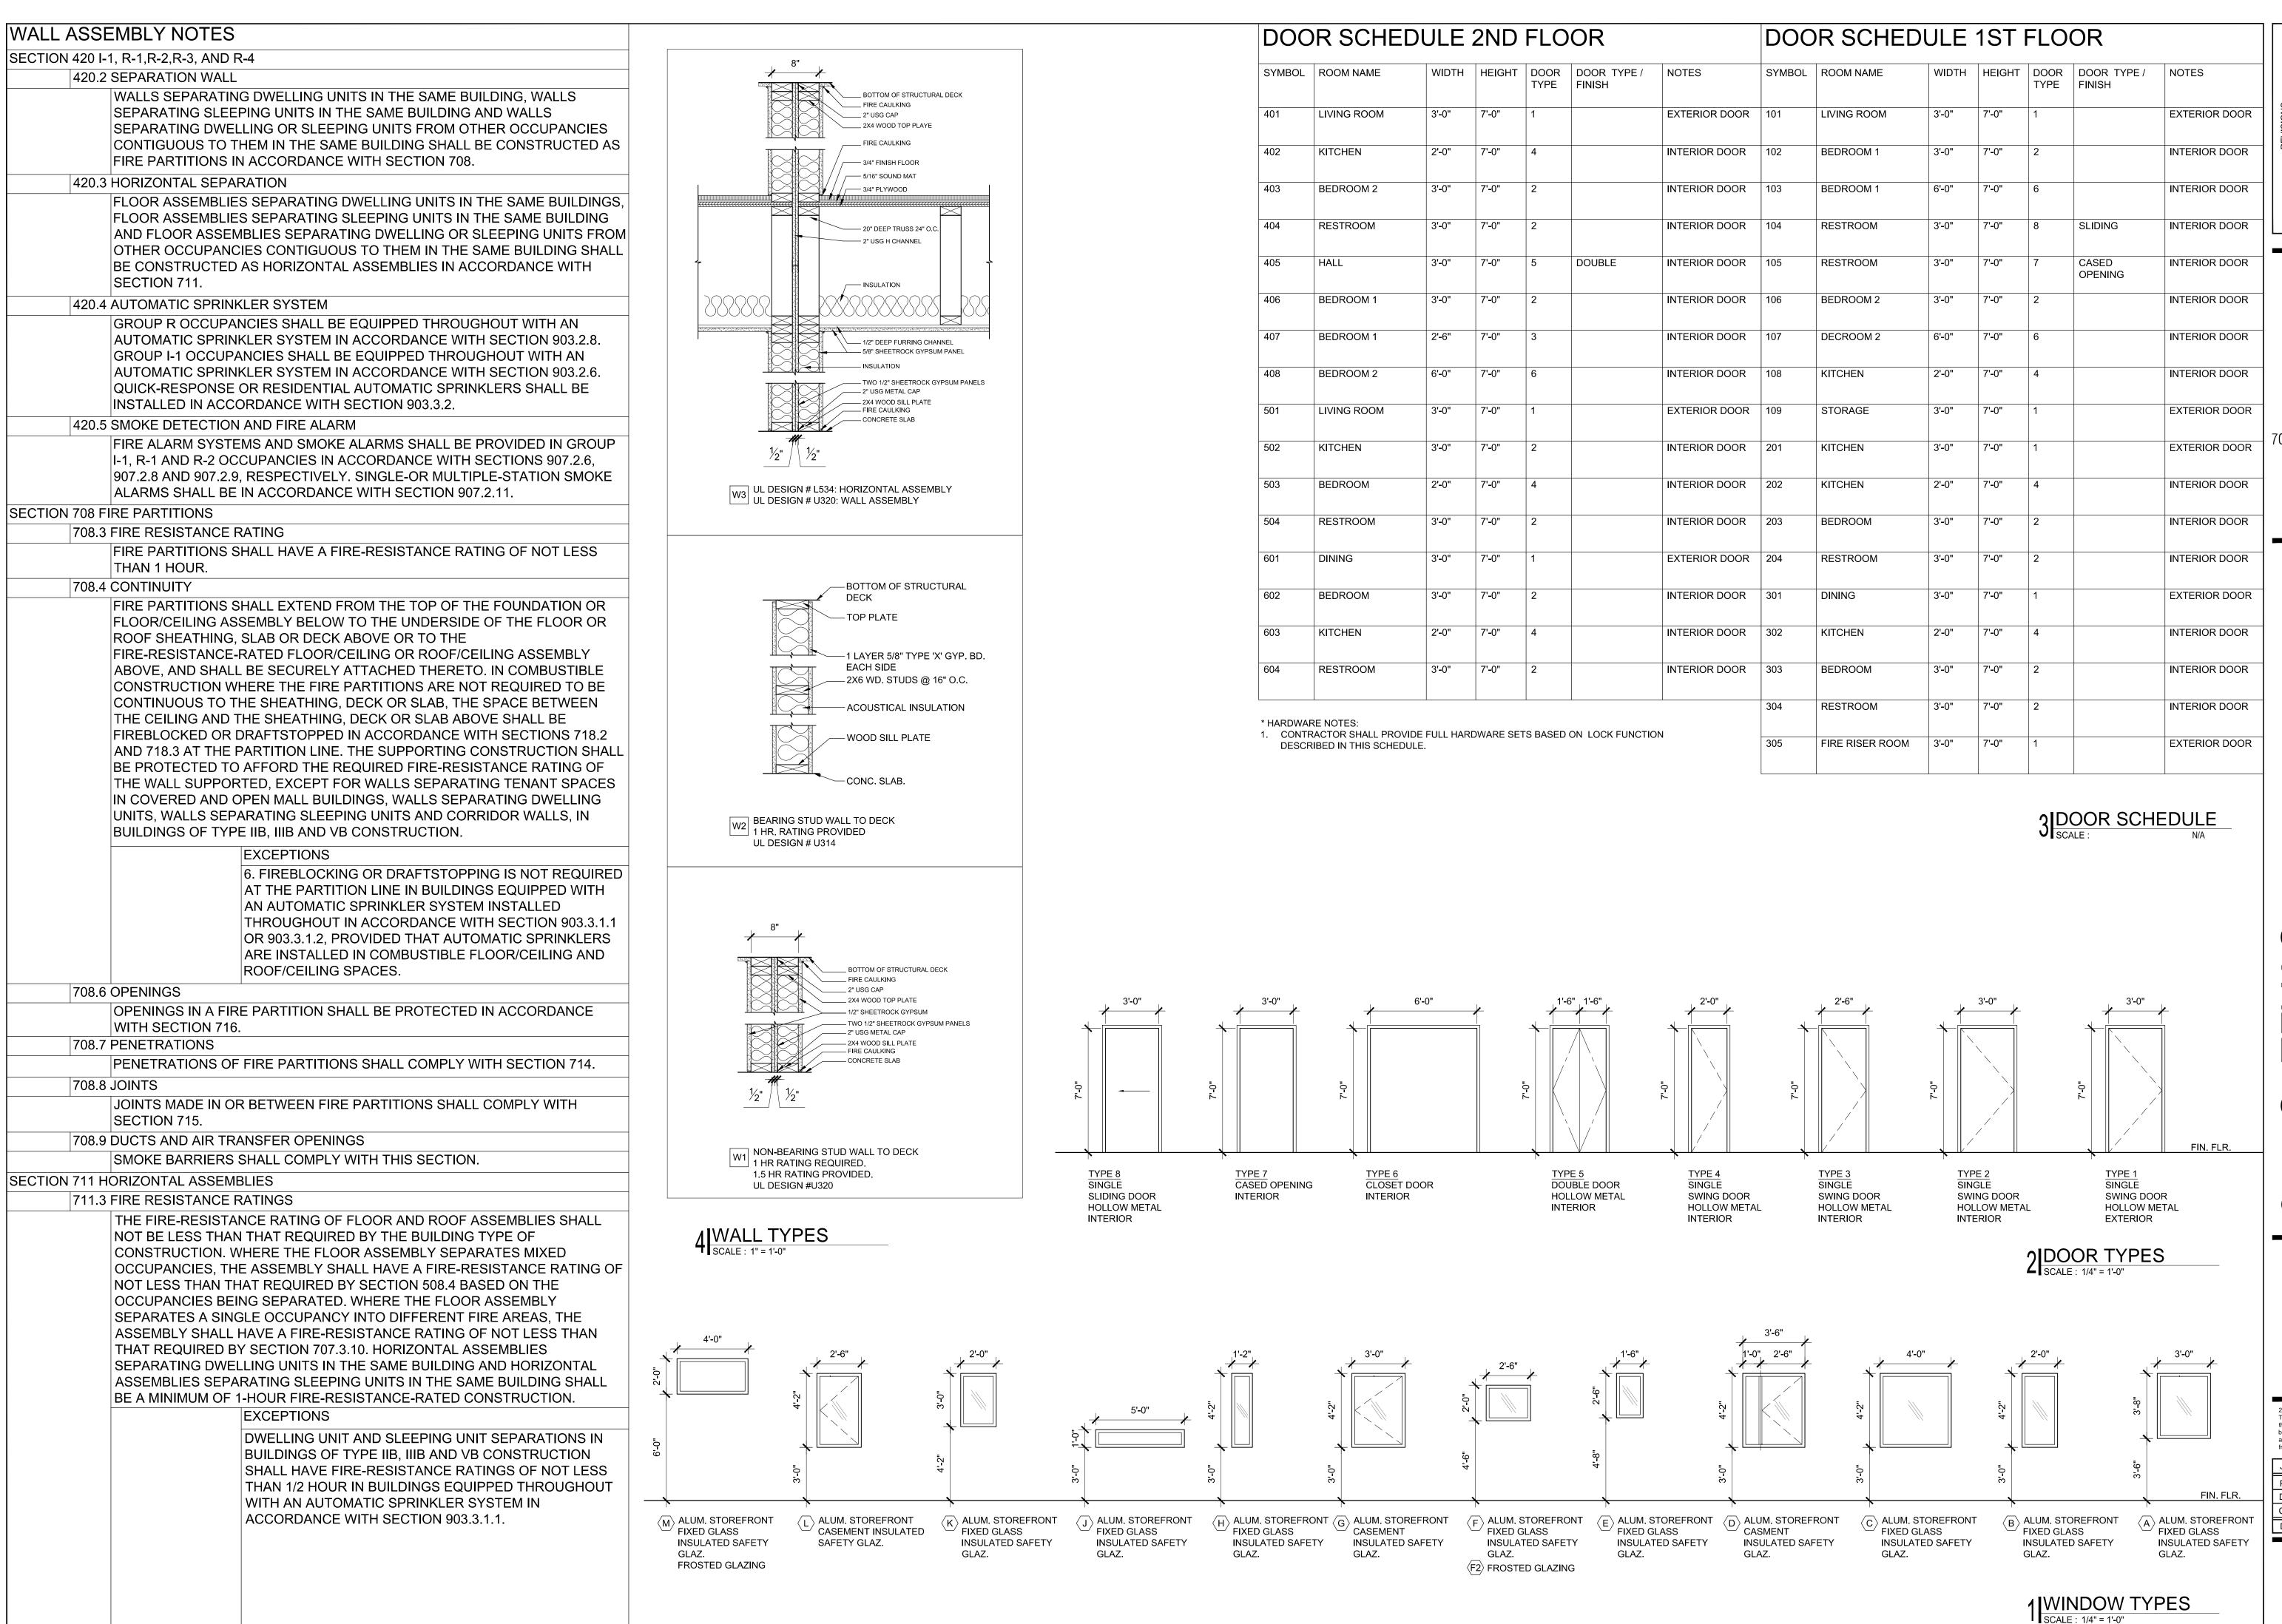



7010 Easy Wind Dr. Ste 200 Austin, TX 78752 512.899.3100

www.designopa.com

251 S. TEXAS HENDERSON, NEVADA 8901

PRICING SET

2018 OPA Design Studio. All Rights Reserved. These designs / drawings are the sole property of the Architect, OPA Design Studio. They may not be reproduced in any form, by any method, for any purpose without previous written permission from the Architect.

from the Architect.

JOB NO.: 201724-C

PHASE: CD

DRAWN: SO, LE, NC

CHECKED: SO

DATE: 03/20/2019

A60'